0 MEADOWBROOK AMENDMENT TO DEFINITIVE SITE PLAN

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Joseph Graham, PE

13 Snow Dr. Westford, MA 01886 (978) 501.2695

REVISION: 3 DATE: 9/10/2024



0 MEADOWBROOK WORCESTER, MA

OWNER/ APPLICANT:

QUALITY WORCESTER LLC **19 CEDAR STREET** WORCESTER, MA

9/10/2024 CITY OF WORCESTER, MA 01609 **BUILDING LOCATION PLAN**

PREPARED BY:





SURVEYED BY:

Robert D. O'Neil Jr. P.L.S.

66 Drury Ln. Worcester, MA 01609 (508) 868-5144



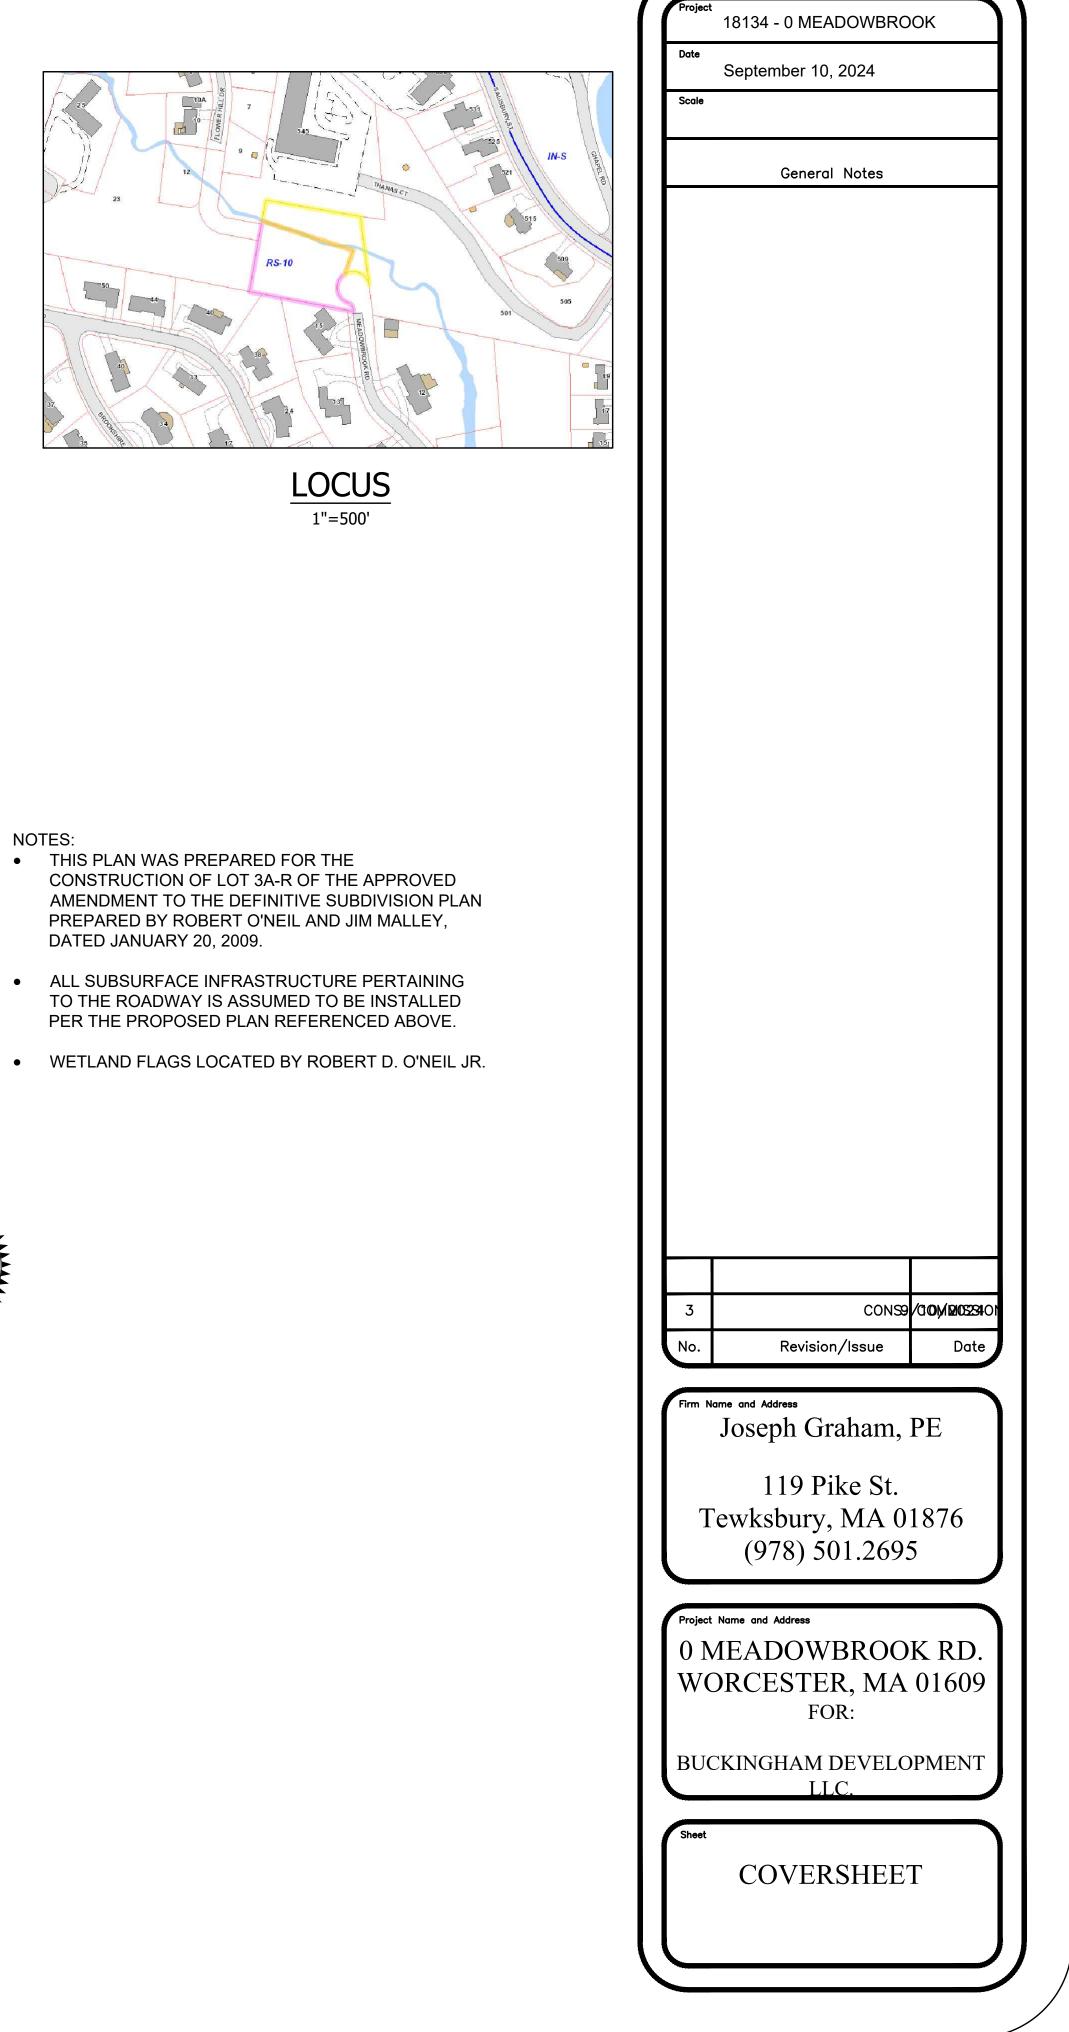

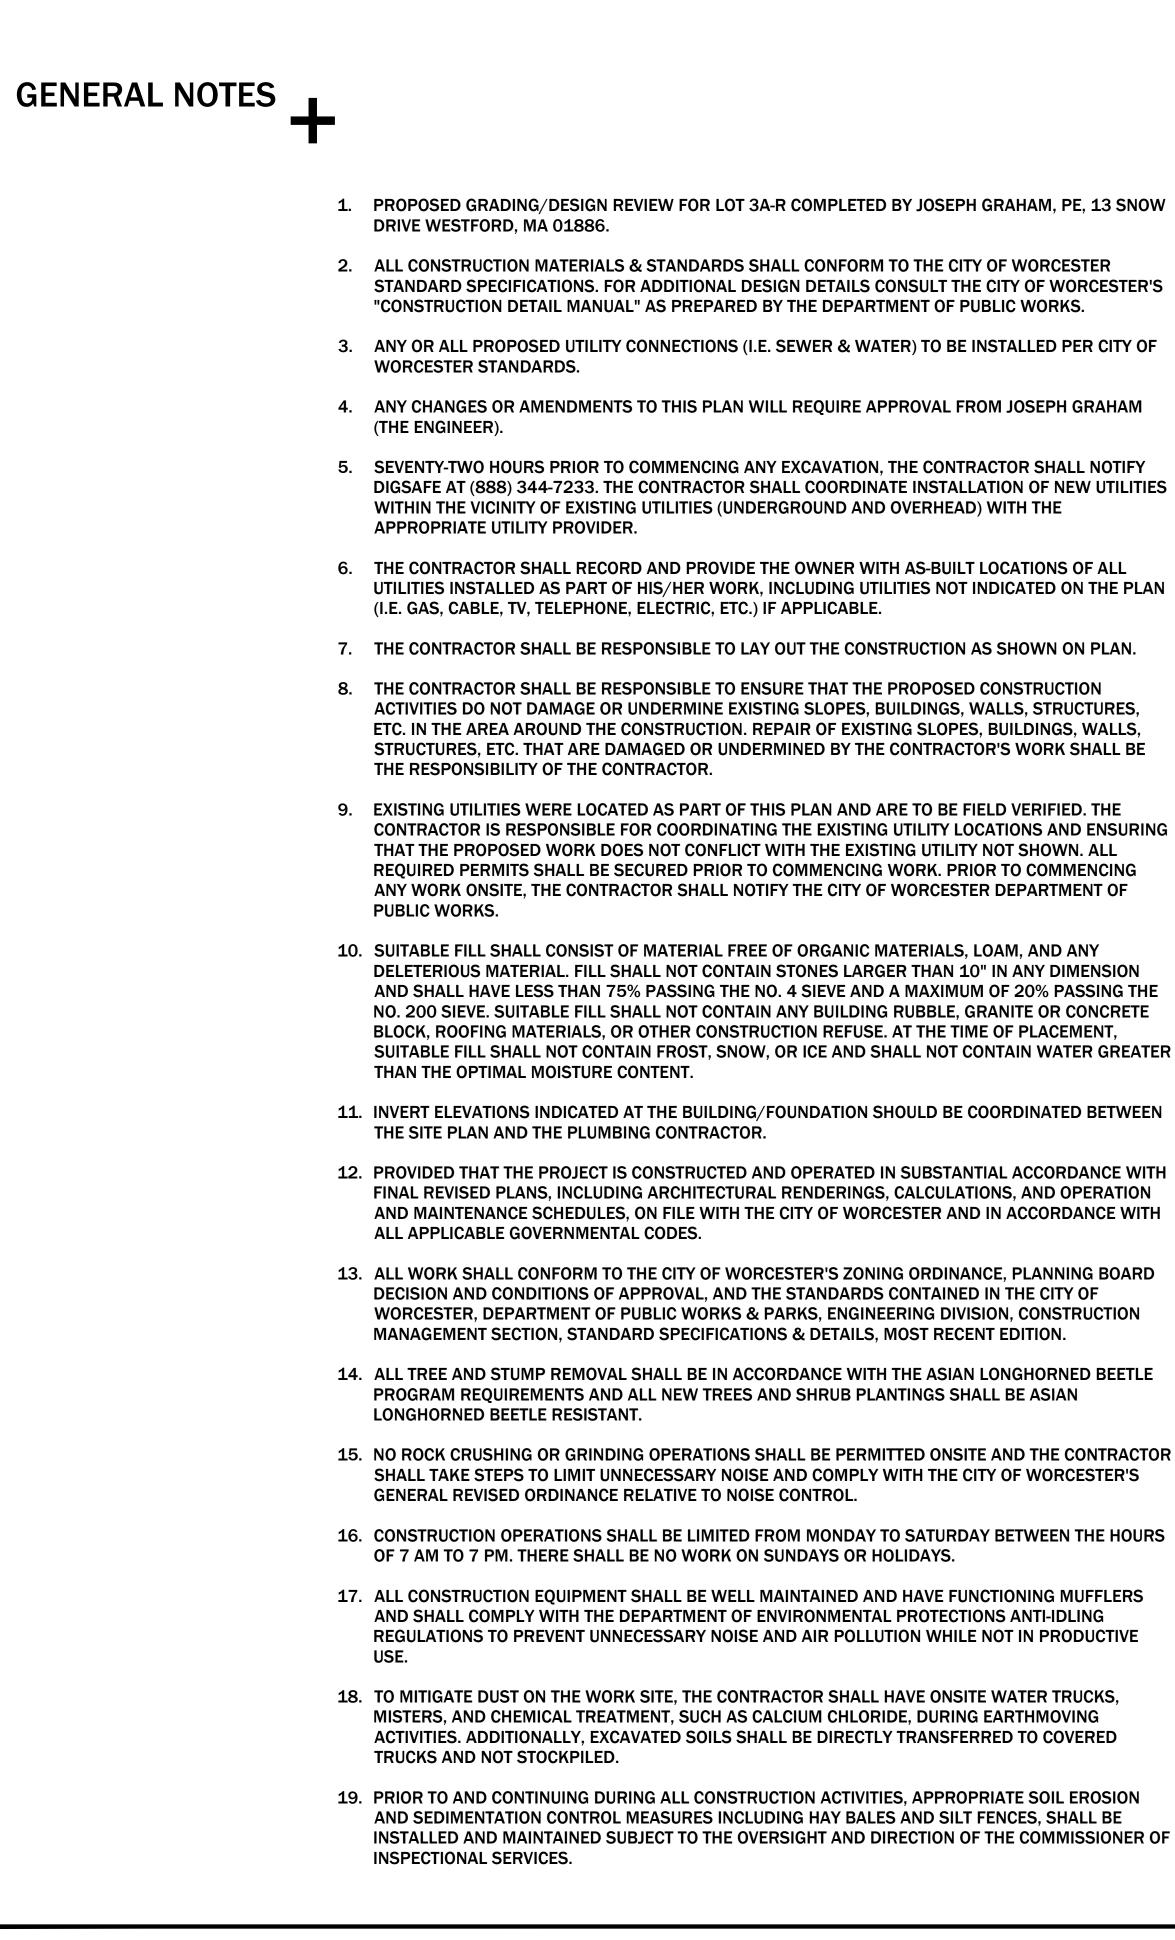

ALL UNDERGROUND UTILITIES SHOWN WERE COMPLIED ACCORDING TO AVAILABLE RECORD PLANS FOR THE VARIOUS UTILITY COMPANIES AND PUBLIC AGENCIES AND ARE APPROXIMATE ONLY. ACTUAL LOCATIONS MUST BE DETERMINED I THE FIELD BEFORE DESIGNING, EXCAVATING, BLASTING, OR INSTALLING, BACKFILLING, GRADING, PAVEMENT RESTORATION, OR REPAIRING. ALL UTILITY COMPANIES, PUBLIC AND PRIVATE, MUST BE CONTACTED, INCLUDING THOSE IN CONTROL OF UTILITIES NOT SHOWN ON THIS PLAN. NOT RESPONSIBLE FOR DAMAGES INCURRED AS A RESULT OF UTILITIES OMITTED OR INACCURATELY SHOWN. THE CONTRACTOR IS TO CONTACT "DIGSAFE" @ 1-888-344.7233 PRIOR TO ANY CONSTRUCTION.

ABBREVIATIONS

DIGSAFE:


W ONEINES	_				
	A.C.I.	AMERICAN CONCRETE INST		OUTSIDE DIAMETER	
OF ALL	BLDG.	BUILDING	U.N.O.	UNLESS NOTED OTHERWISE	
N THE PLAN	CONC.	CONCRETE	REF.	REFERENCE	
	C.J.	CONTROL JOINT	R.	RISER	
	COL.	COLUMN	R.O.	ROUGH OPENING	
	DET.	DETAIL	RM.	ROOM	
N PLAN.	DIA.	DIAMETER	S/STL.	STAINLESS STEEL	
ON	DN.	DOWN	STRUCT.	STRUCTURAL	
CTURES,	EL/ELEV.	ELEVATION	SPEC.	SPECIFICATIONS	
WALLS,	ELEC.	ELECTRICAL	Т.О.	TOP OF ()	
SHALL BE	EQ.	EQUAL	T.O.CONC.	TOP OF CONCRETE	
	FIN.	FINISH	T.O.F.	TOP OF FRAMING	
	FLR.	FLOOR	T.O.STL.	TOP OF STEEL	
	GALV.	GALVANIZED	T.O.W.	TOP OF WALL	
D. THE	GYP.	GYPSUM	TYP.	TYPICAL	
) ENSURING					
I. ALL	I.D.	INSIDE DIAMETER	@	AT	
ENCING	JT.	JOINT	+	AND	
ENT OF	MECH.	MECHANICAL	BD.	BOARD	
	MIN.	MINIMUM	A.F.F.	ABOVE FINISHED FLOOR	
	N.T.S.	NOT TO SCALE	U.N.O.	UNLESS OTHERWISE NOTED	
	NO.	NUMBER	V.I.F.	VERIFY IN FIELD	
NY	0.C.	ON CENTER	V.I.I .	VENITINTIEED	
IENSION					
SSING THE	OPG.	OPENING			
ONCRETE					
1ENT,					
ER GREATER					
) BETWEEN					
) BEI WEEN					
ANCE WITH					
PERATION					
ANCE WITH					
IG BOARD					
OF					
RUCTION					
Conon					
D BEETLE					
ONTRACTOR					
ESTER'S					
THE HOURS					
UFFLERS					
ING					
DUCTIVE					
JCKS,					
NG					
ERED					


S	YMBOLS		DATE APPR
EXISTING JB	PROPOSED JB	DESCRIPTION JERSEY BARRIER ON BRIDGE OR JERSEY BARRIER	COMMISSION
■ ⊕ ⊕ CB © FP	€ FP	CATCH BASIN CATCH BASIN CURB INLET	
G GP □ MB	G GP D MB	FLAG POLE GAS PUMP MAIL BOX	CONS DESCRIPTION
		POST SQUARE POST CIRCULAR	L L L L L L L L L L L L L L L L L L L
⊕ WELL □ EHH ○	⊕ WELL □ EHH ○	WELL ELECTRIC HANDHOLE FENCE CATE POST	ن ن
o GG	O GG → → OR →	FENCE GATE POST GAS GATE SIGN	
● BHL # ● MW #	 ● BHL # ◆ MW # 	BORING HOLE MONITORING WELL	
■ TP #	■ TP#	TEST PIT HYDRANT	
∽ □ CO.BD. □ △	*	LIGHT POLE COUNTY BOUND GPS POINT	QUAL
© ©	© ©	CABLE MANHOLE DRAINAGE MANHOLE	D Q L
(E) (G) (i)	Ē	ELECTRIC MANHOLE GAS MANHOLE	Ř
(M) (S) (T)	(M) (S) (T)	MISC MANHOLE SEWER MANHOLE TELEPHONE MANHOLE	μ
₩ ₩ ■ MHB		WATER MANHOLE MASSACHUSETTS HIGHWAY BOUND	
□ MON □ SB		MONUMENT STONE BOUND	
■ TB △ ⊸ TPL or GUY	-> TPL or GUY	TOWN OR CITY BOUND TRAVERSE OR TRIANGULATION STATION	WOR
 HTP → UFB 	-⊱ UFB	TROLLEY POLE OR GUY POLE TRANSMISSION POLE UTILITY POLE W/ FIREBOX	Š
-∲- UPDL -&- ULT	-∲- UPDL -&- ULT	UTILITY POLE WITH DOUBLE LIGHT UTILITY POLE W / 1 LIGHT	
UPL O	-∽- UPL	UTILITY POLE BUSH	DESIGNED BY JRG DRAWN BY JRG CHECKED BY JRG
•SIZE & TYPE 0 		TREE STUMP	
• WG • PM	∘ WG ∘ PM	SWAMP / MARSH WATER GATE PARKING METER	~
			ISSION
			AN MIN
			COMM
			_
			S N S N
			CONS
		OTHERLITH OF MASS ACLES	
		CIVIL NO. 53706 RC/STERED	DRAWING NO. 18134_GO.1 SCALE: AS NOTED


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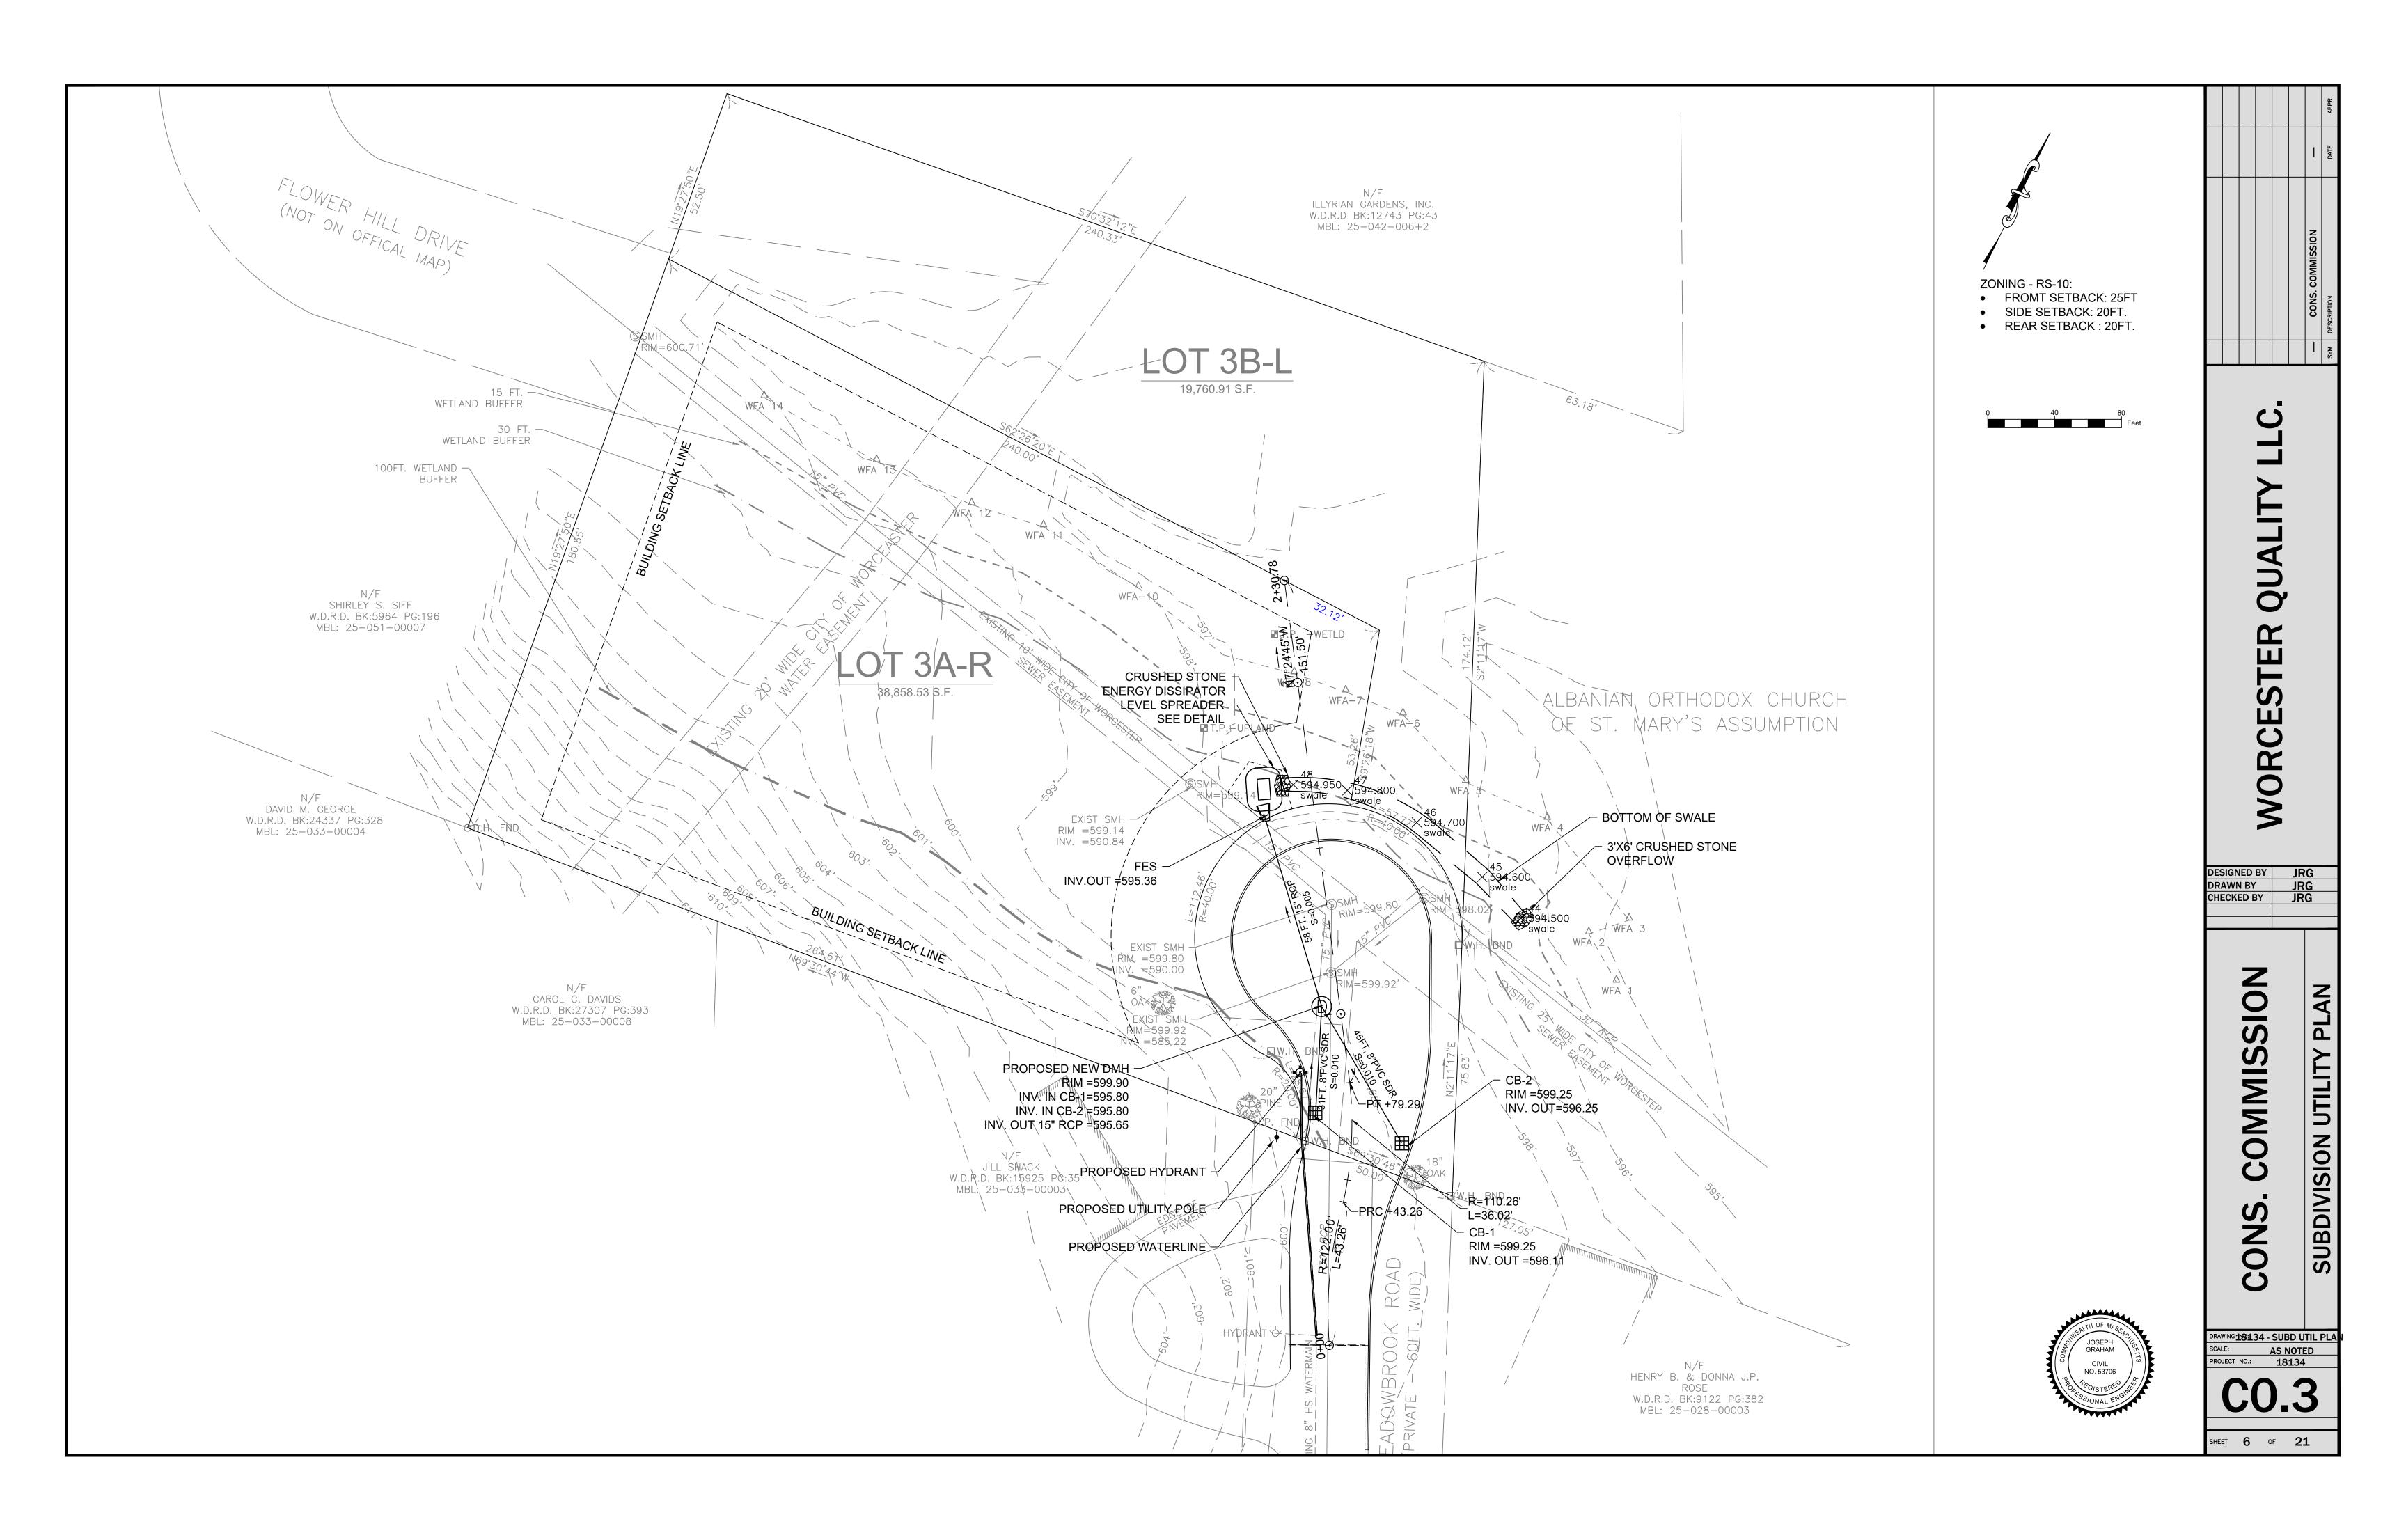
GO.:

SHEET 2 OF 21



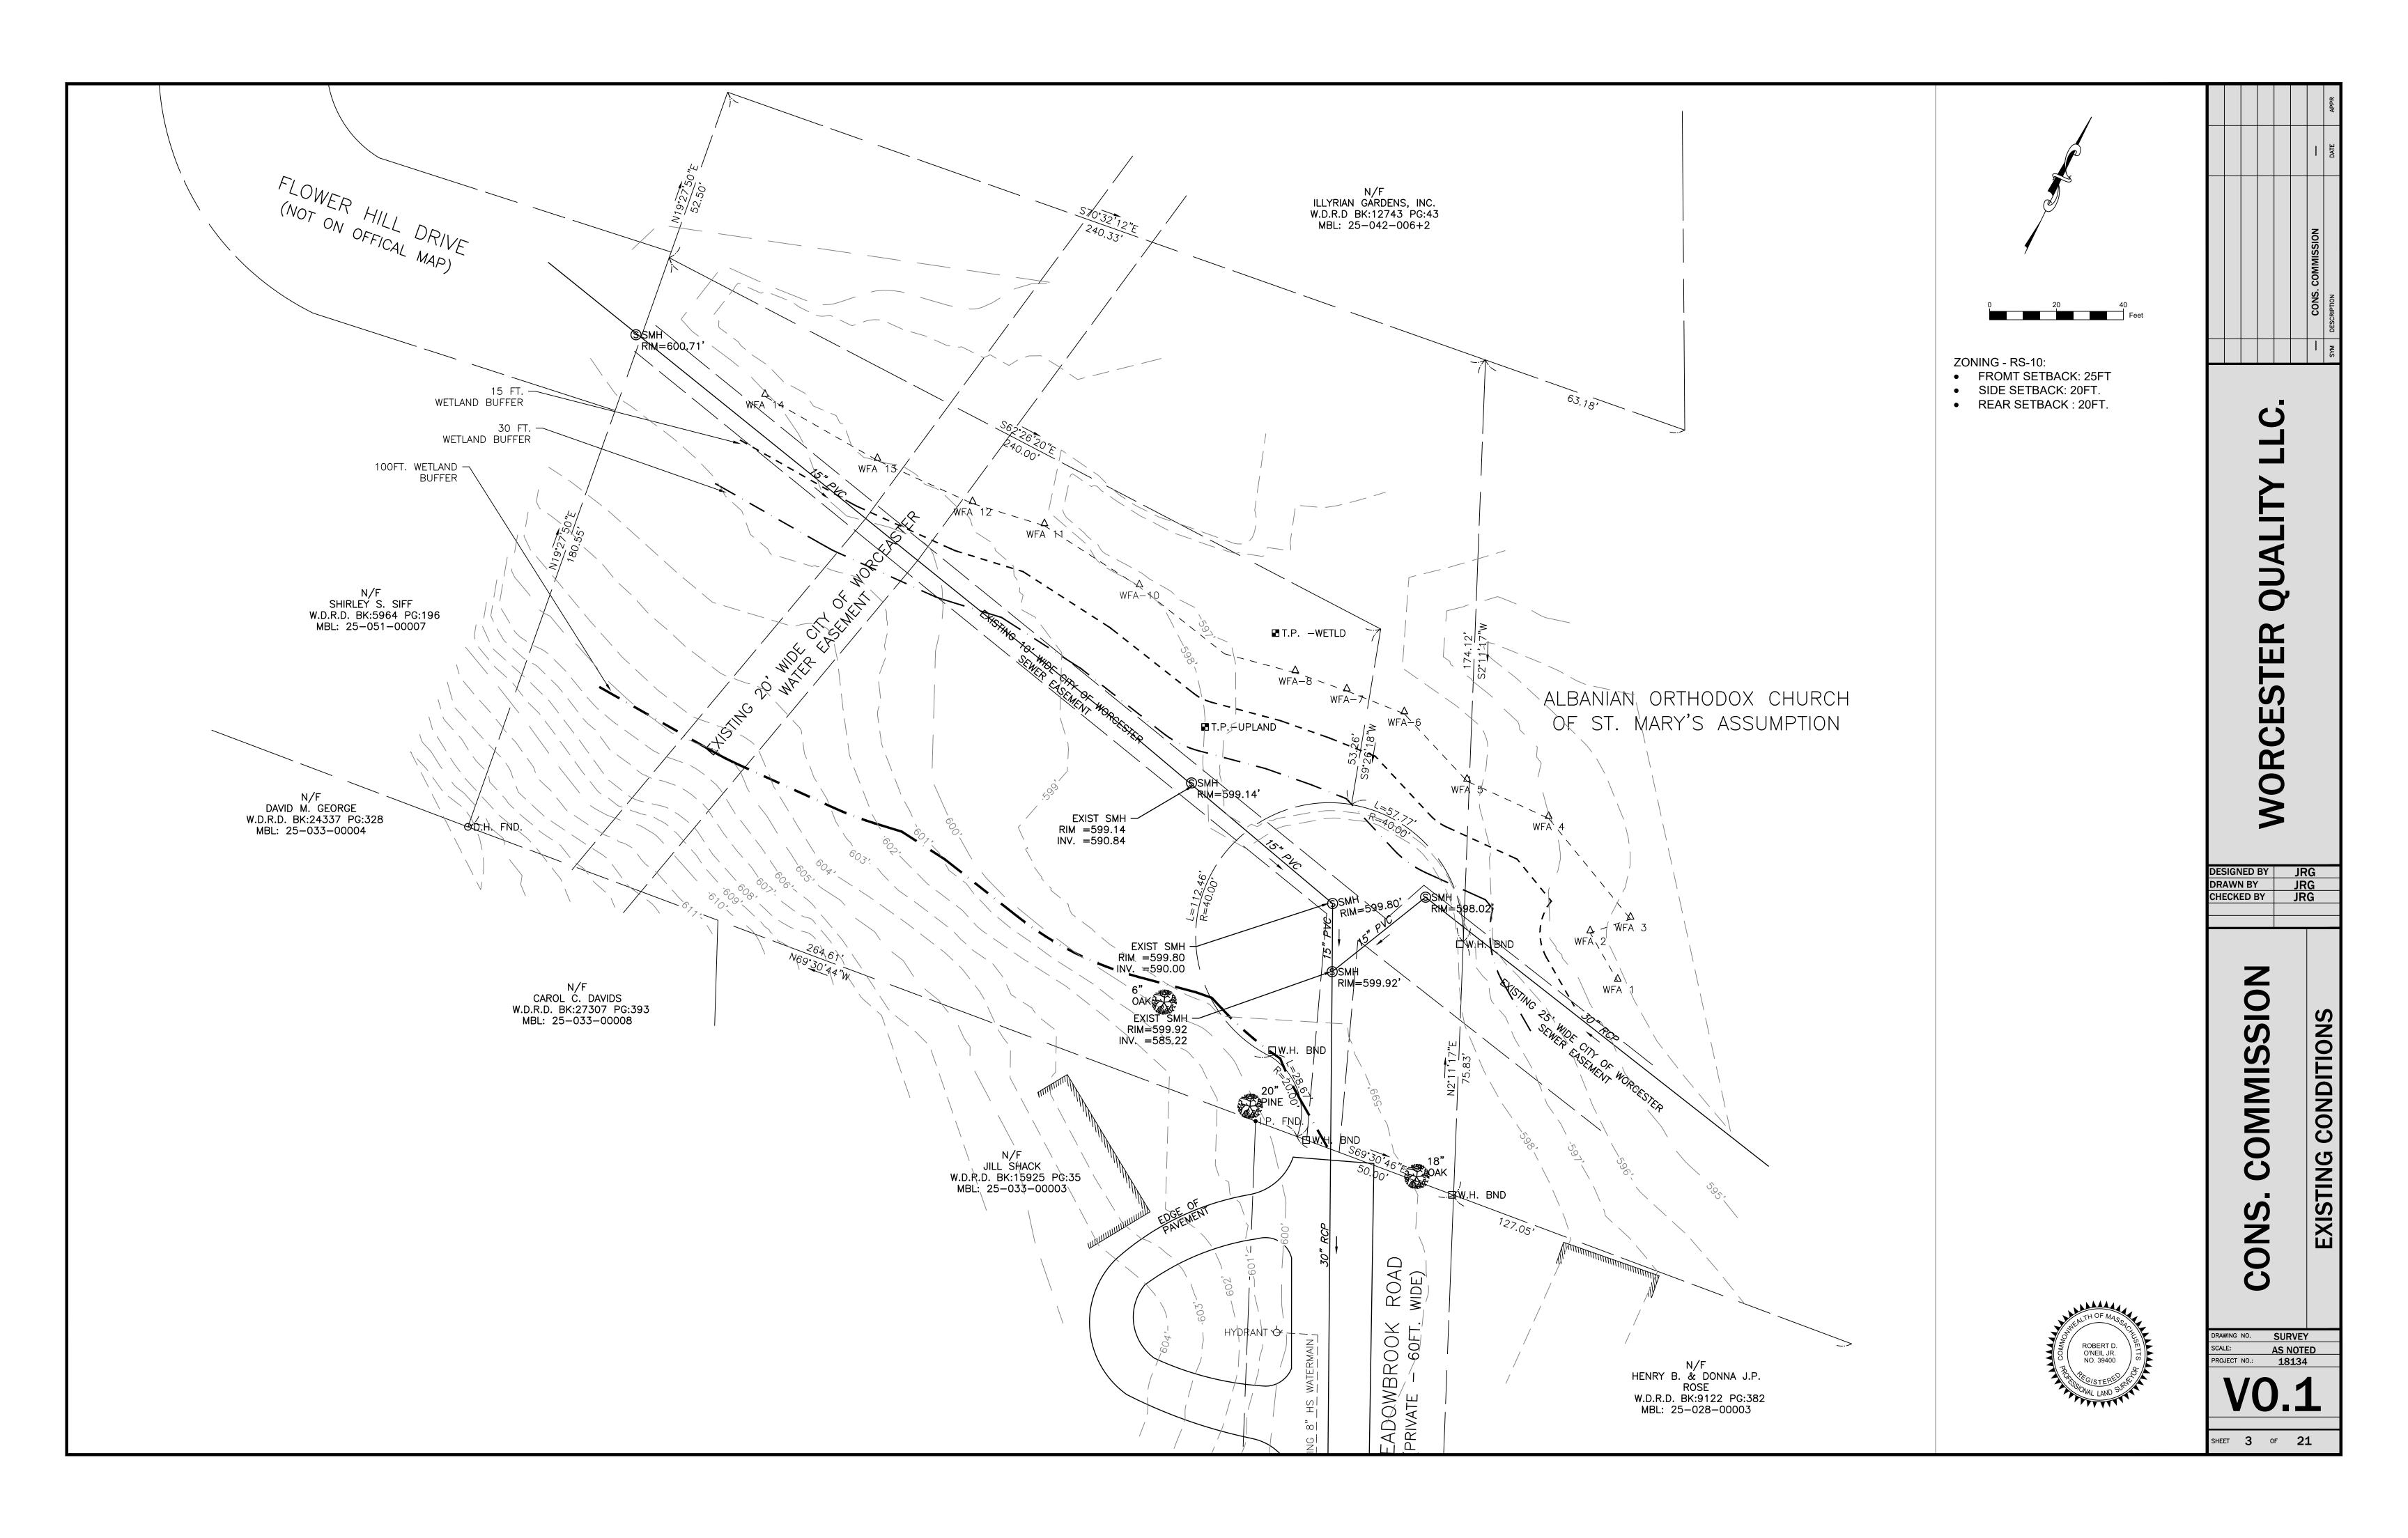

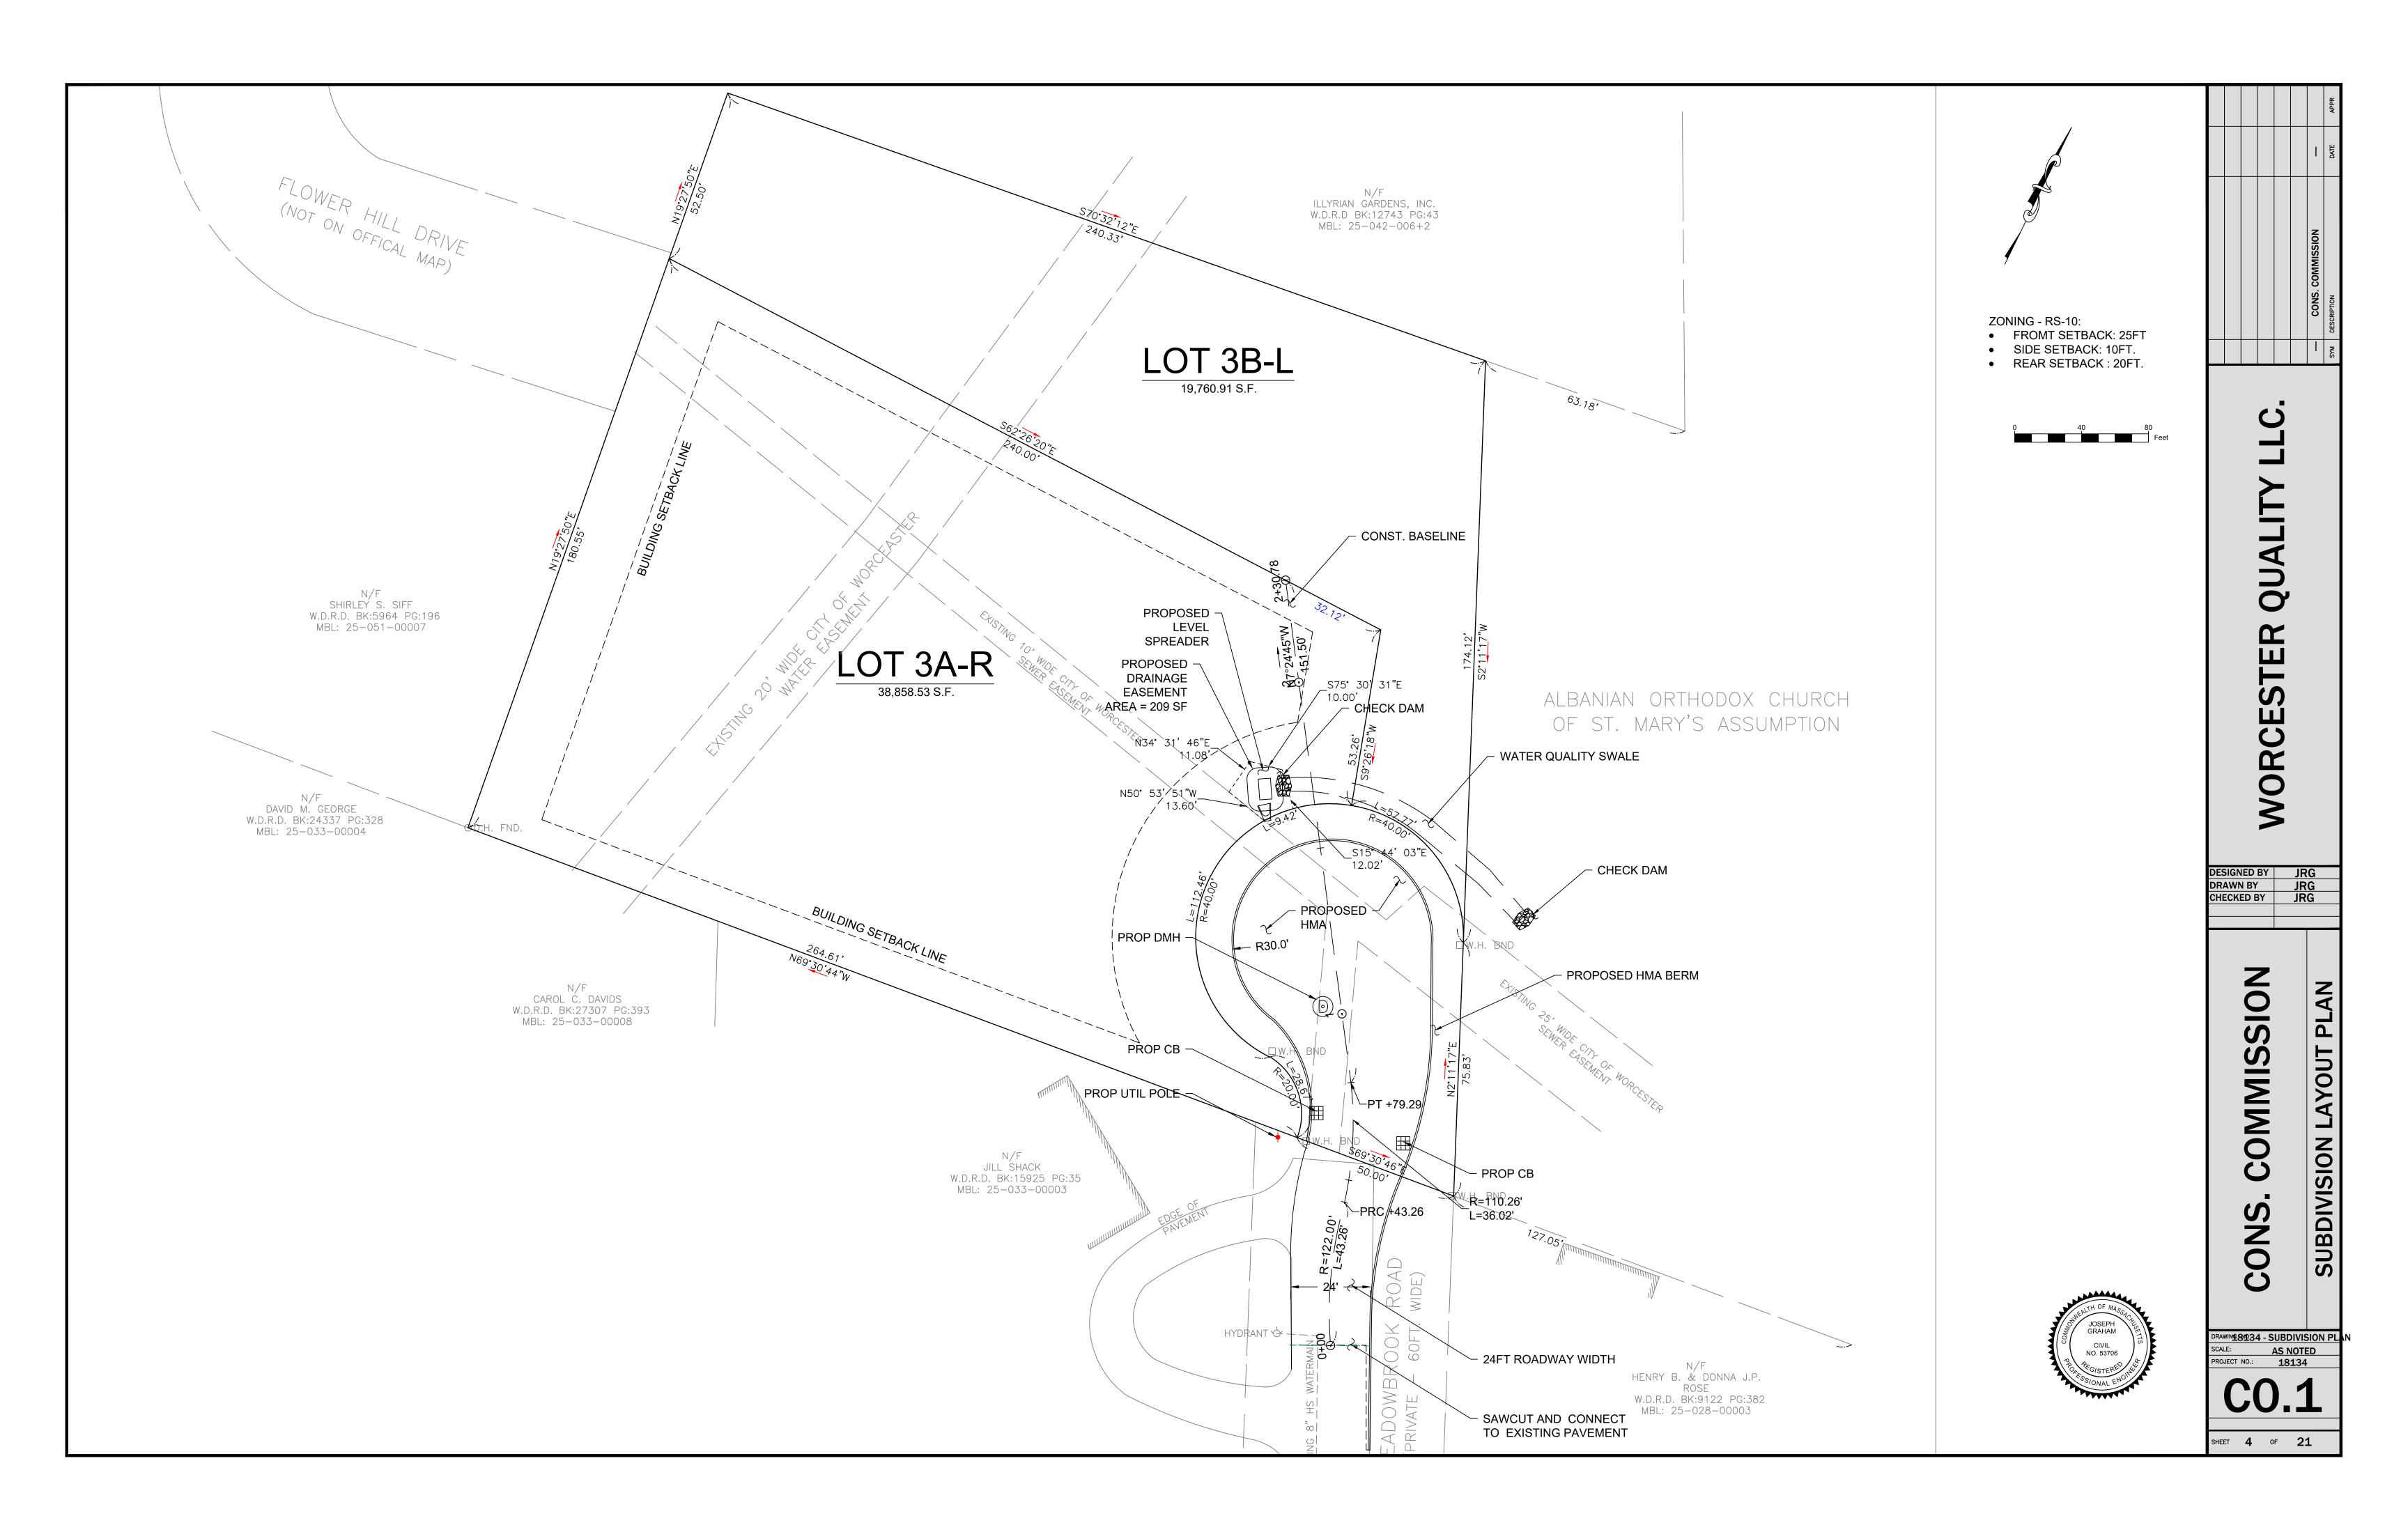


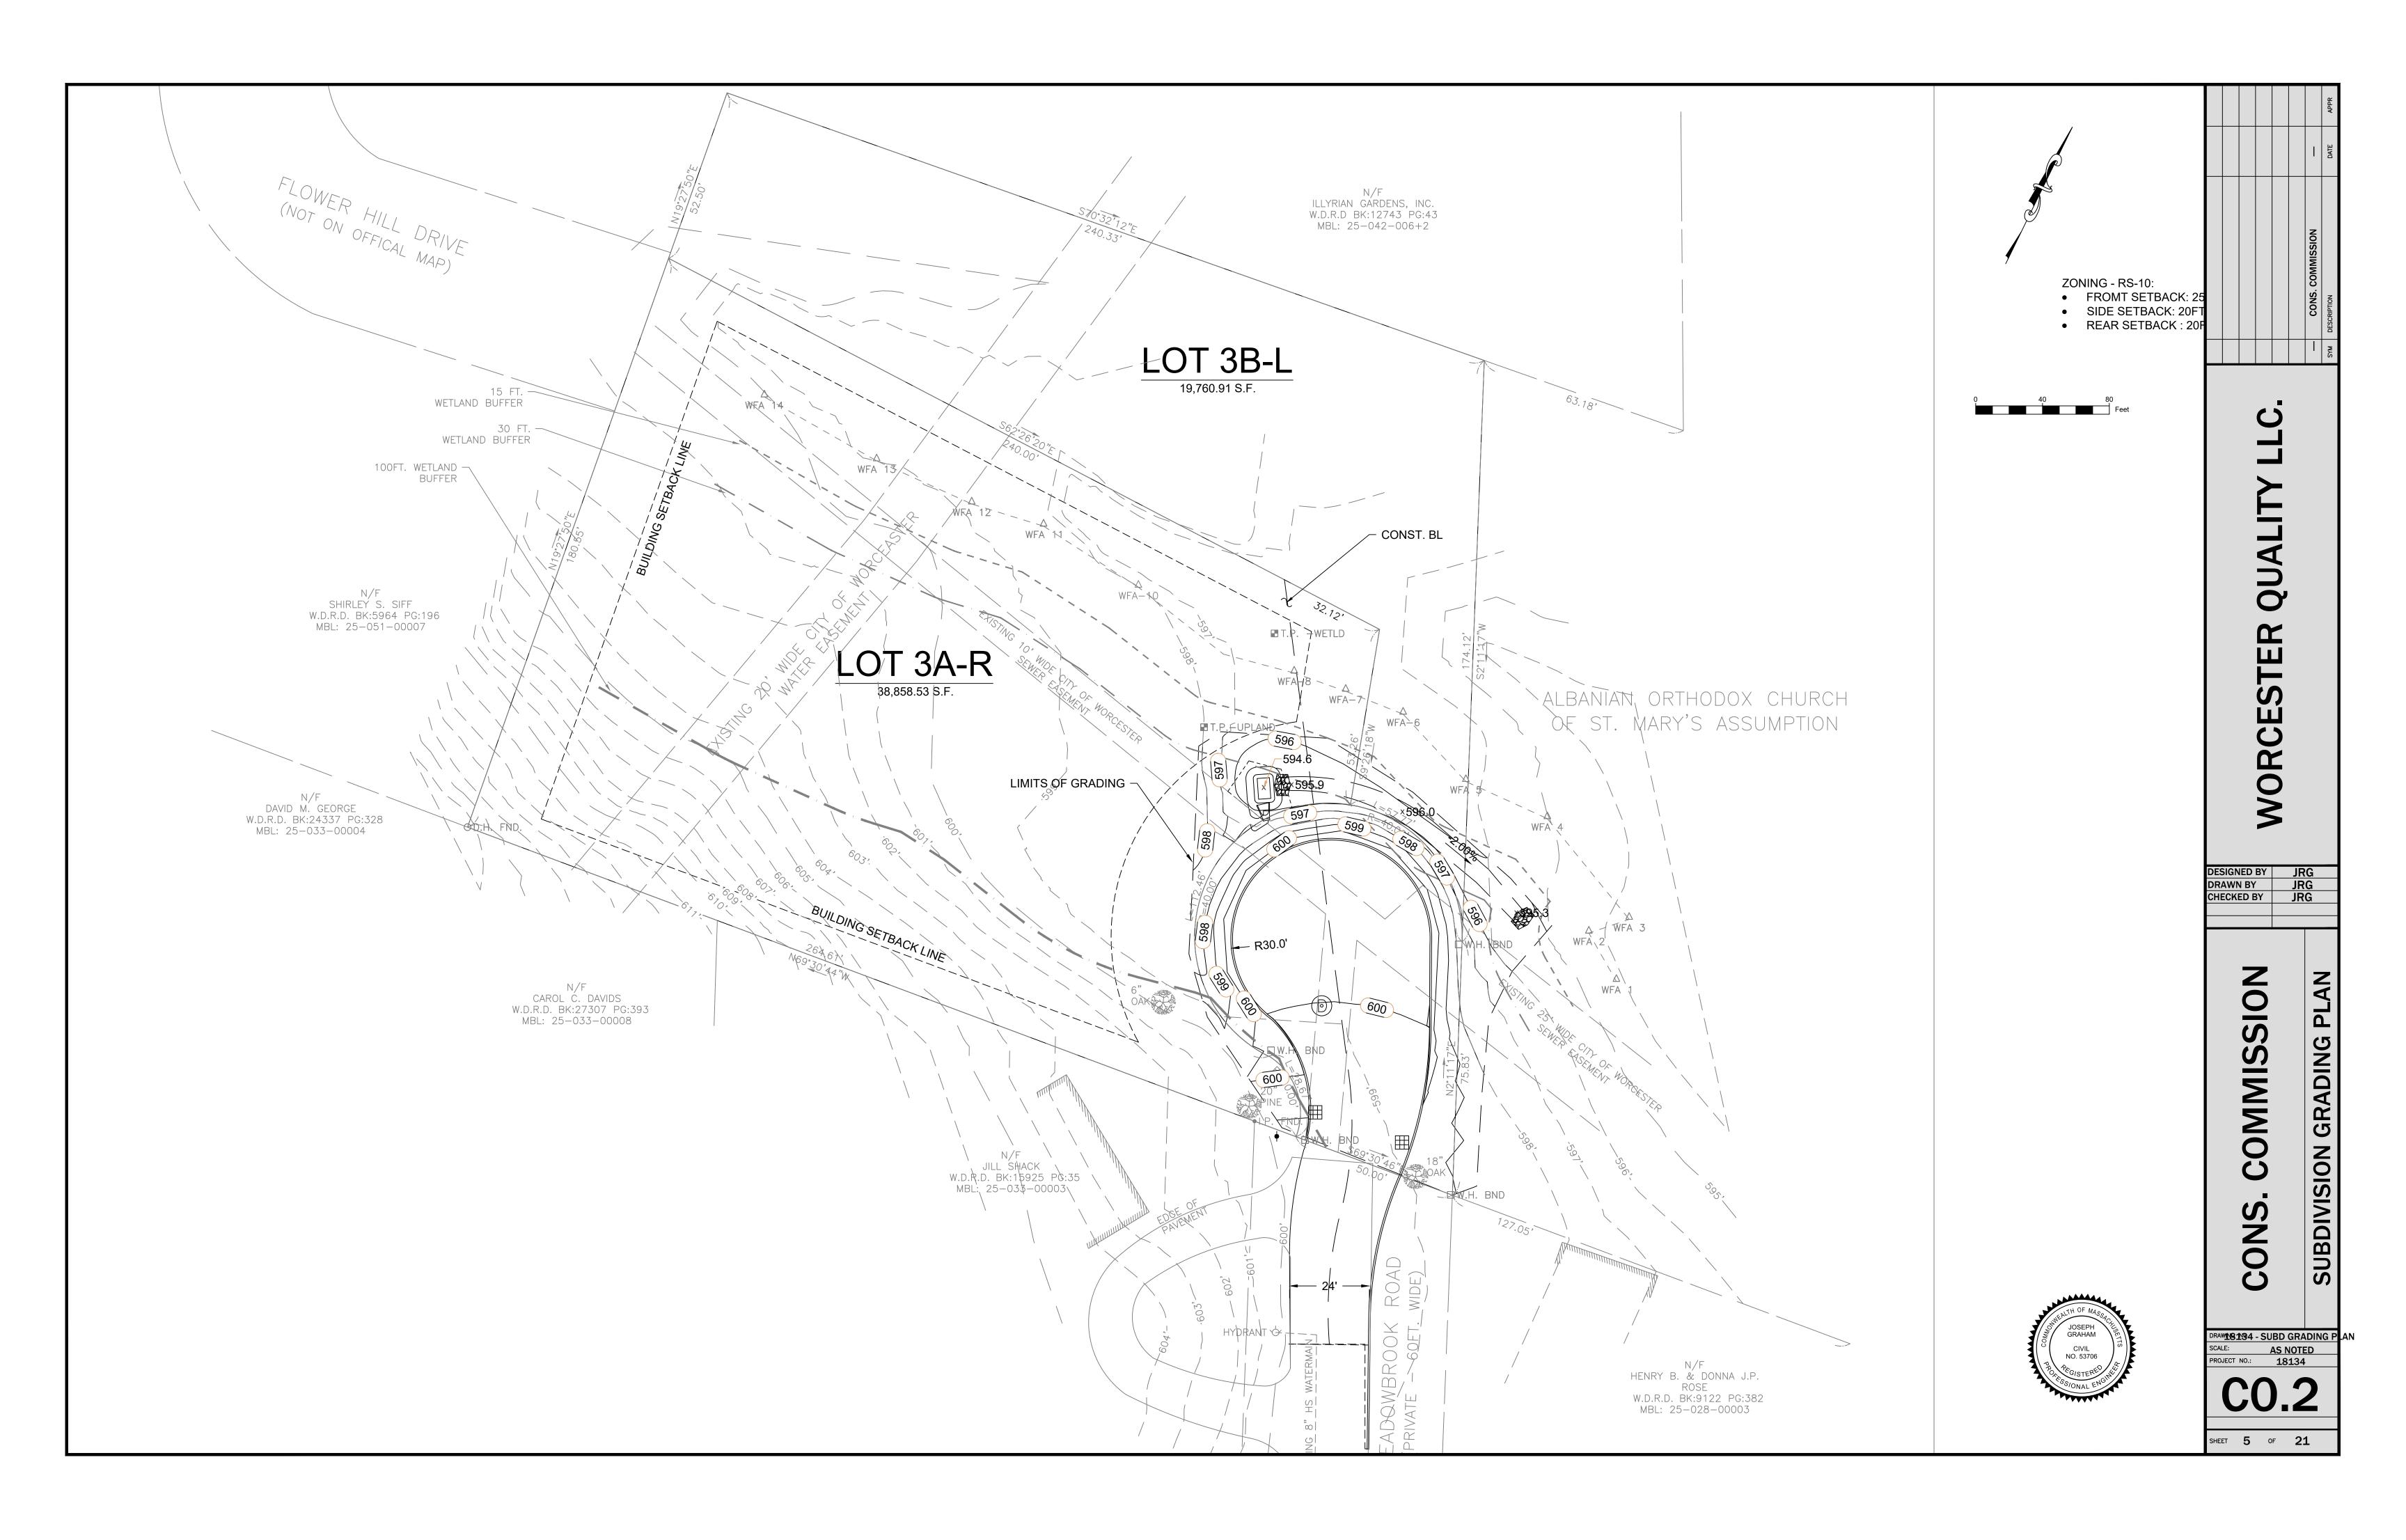



PROPOSED CONSTRUCTION SEQUENCE


PROJECT TO BE CONSTRUCTED IN SUBSTANTIAL ACCORDANCE WITH THE FINDINGS OF FACT AND ALL FINAL PLANS RECORDED WITH THE CITY OF WORCESTER STANDARD SPECIFICATIONS.


- 1. HAYBALE SILTATION FENCING WILL BE INSTALLED ALONG THE PERIMETER OF THE SITE AND TO REMAIN IN PLACE UNTIL ALL SLOPES ARE STABILIZED.
- 2. INSTALL EROSION CONTROL TRACK PAD PRIOR TO COMMENCING EARTHWORK OPERATION
- 3. SILT SACKS SHALL BE INSTALLED UPON COMMENCEMENT OF SITE WORK. SILT SACKS WILL BE MAINTAINED AND CHECKED ROUTINELY AS PART OF THE SWPPP.
- 4. BEGIN SITE WORK FOR THE EXCAVATION AND INSTALLATION OF FOUNDATIONS FOR UNITS 4A&B, 5A&B AND 6A&B. EXCAVATION AND FOUNDATION INSTALLATION SHOULD BE DONE IN PONE PHASE TO LIMIT EXPOSURE OF EXCAVATED SOILS.
- 5. UPON COMPLETION OF FOUNDATIONS, SITE SHOULD BE ROUGH GRADED AND EROSION CONTROL STABILIZING HYDROSEED MIX PLACED.
- 6. DRIVEWAYS WILL BE INSTALLED TO PROVIDE INTERIOR CONTRACTOR PARKING AS BUILDING FRAMING AND CONSTRUCTION CONTINUES.
- 7. AREAS OUTSIDE OF THE BUILDING ENVELOP WILL BE FINISHED GRADES AND ALLOW INSTALLATION OF TREE PLANTINGS AS AVAILABLE.
- 8. ONCE BUILDING ENVELOPE IS COMPLETED AND TREES PLANTED REMAINING AREAS WILL BE FINISHED GRADED AND HYDROSEEDED.

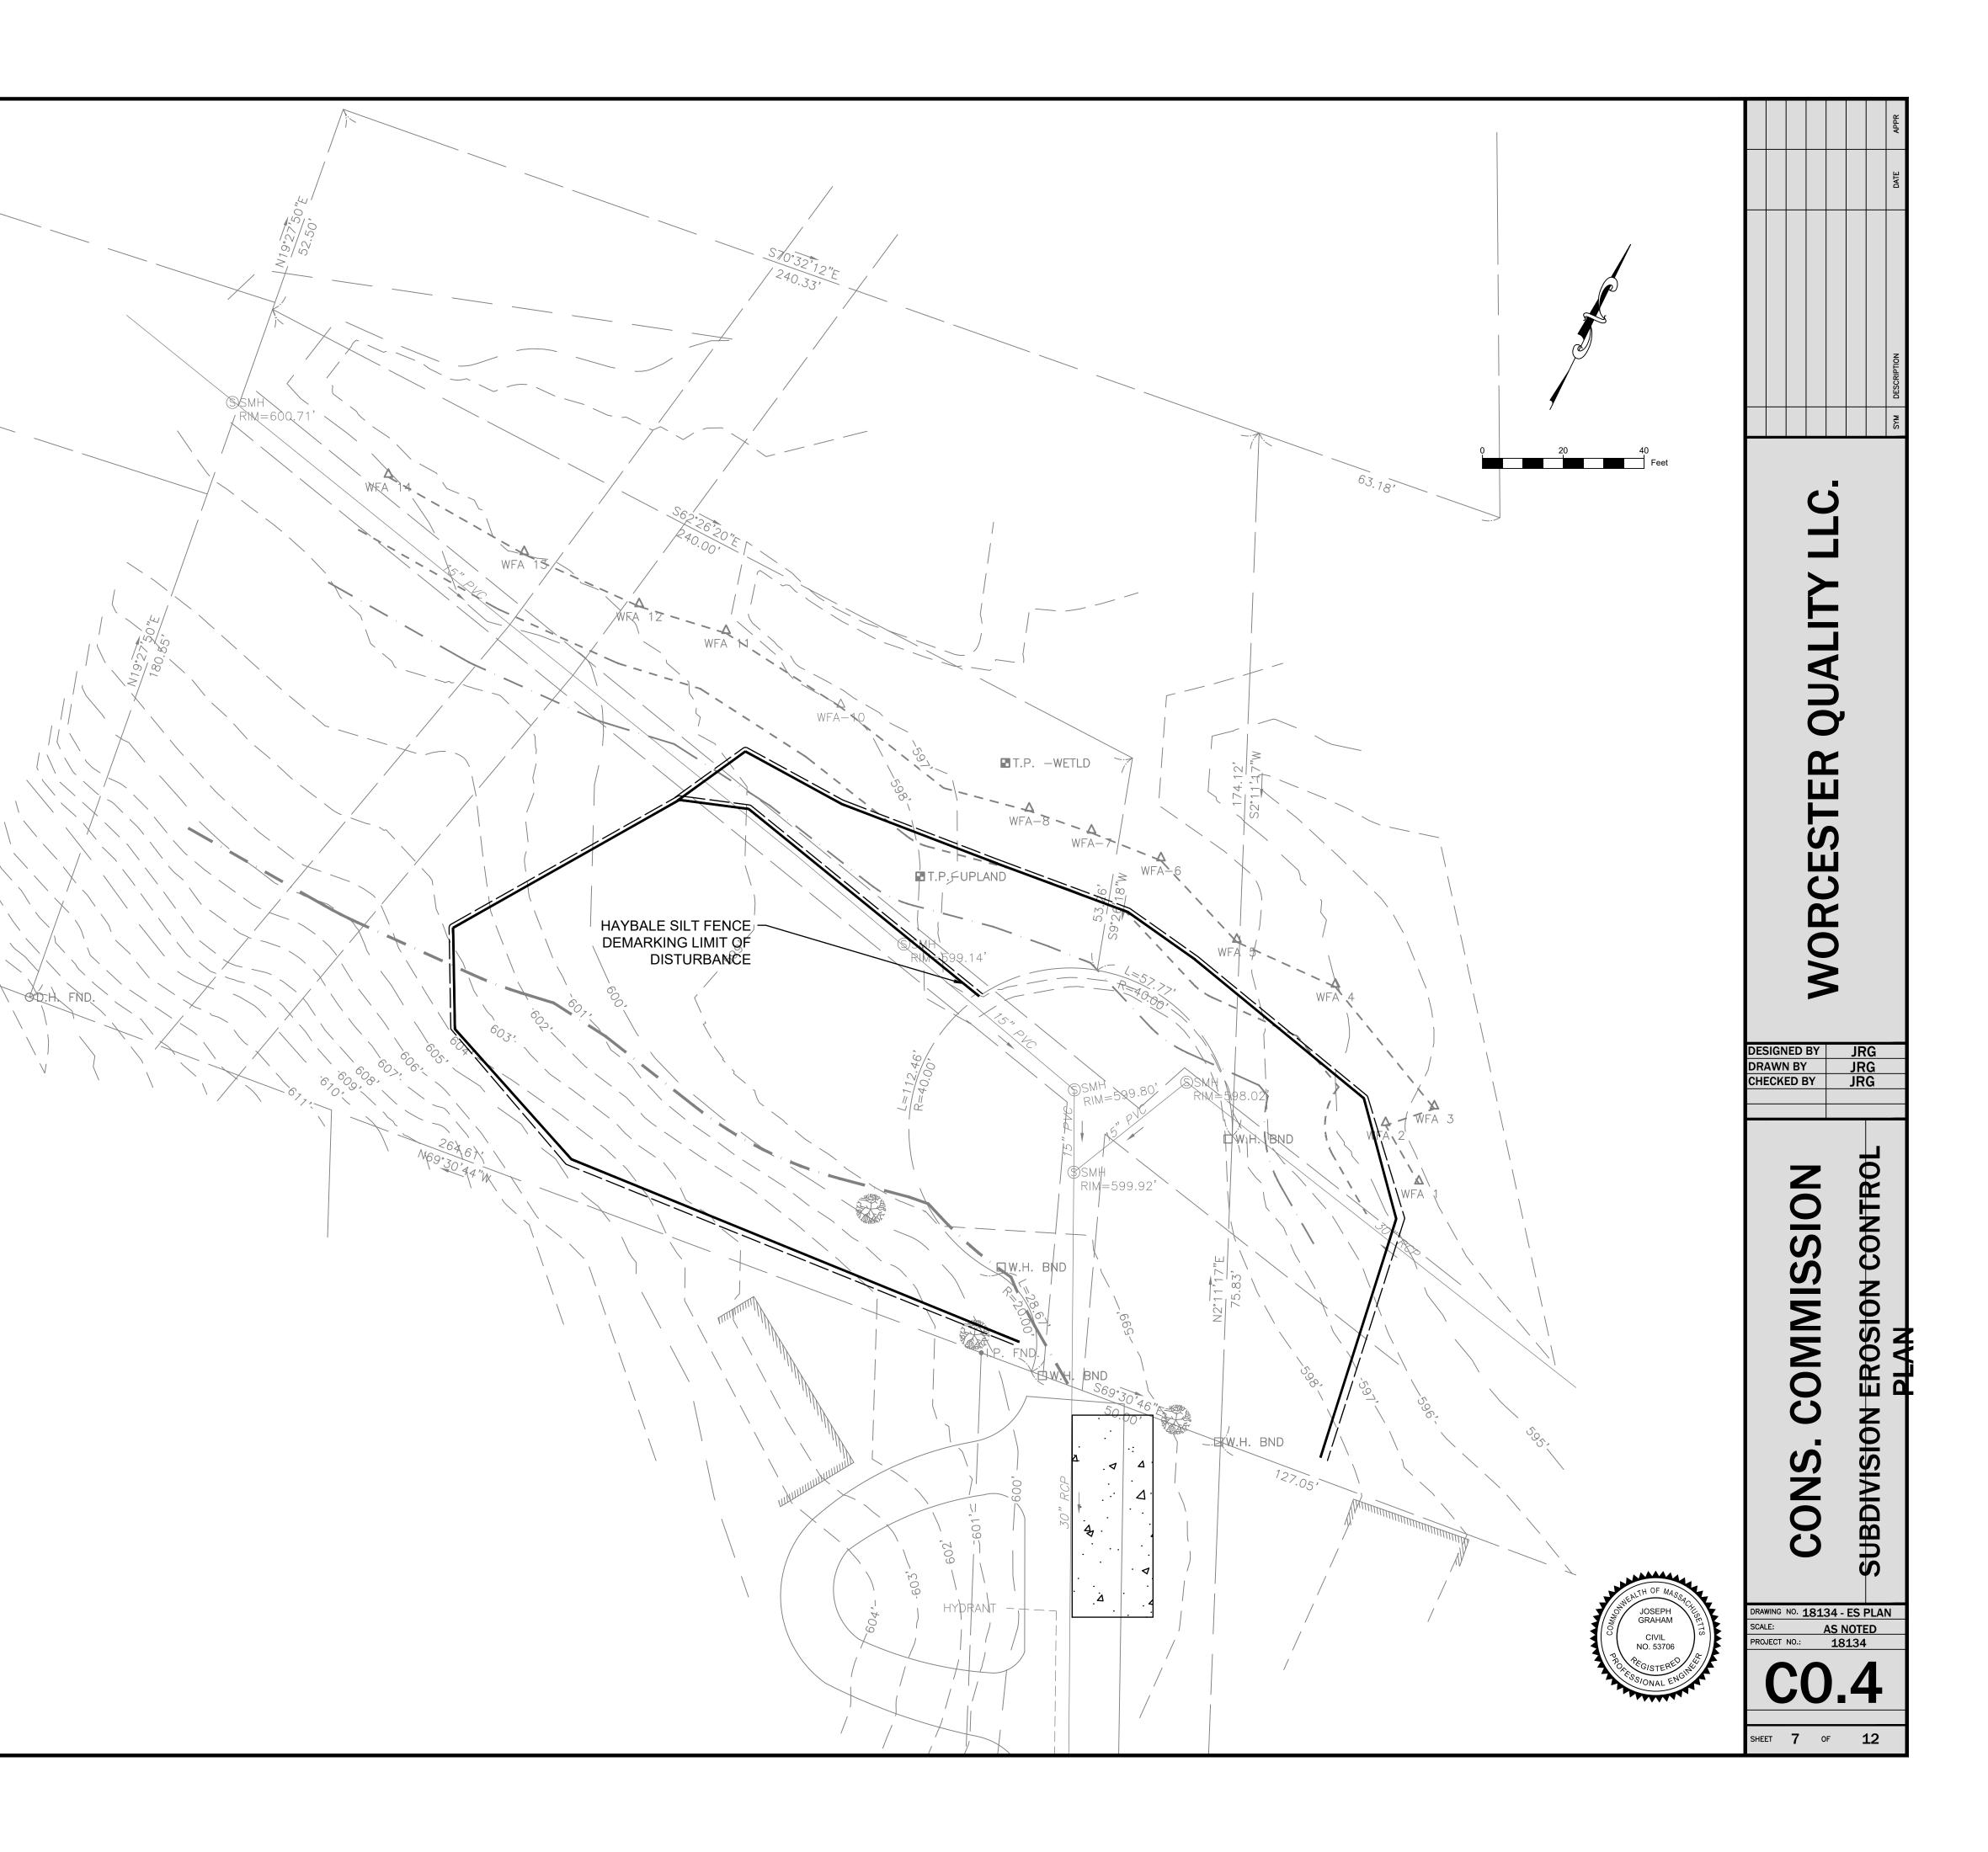


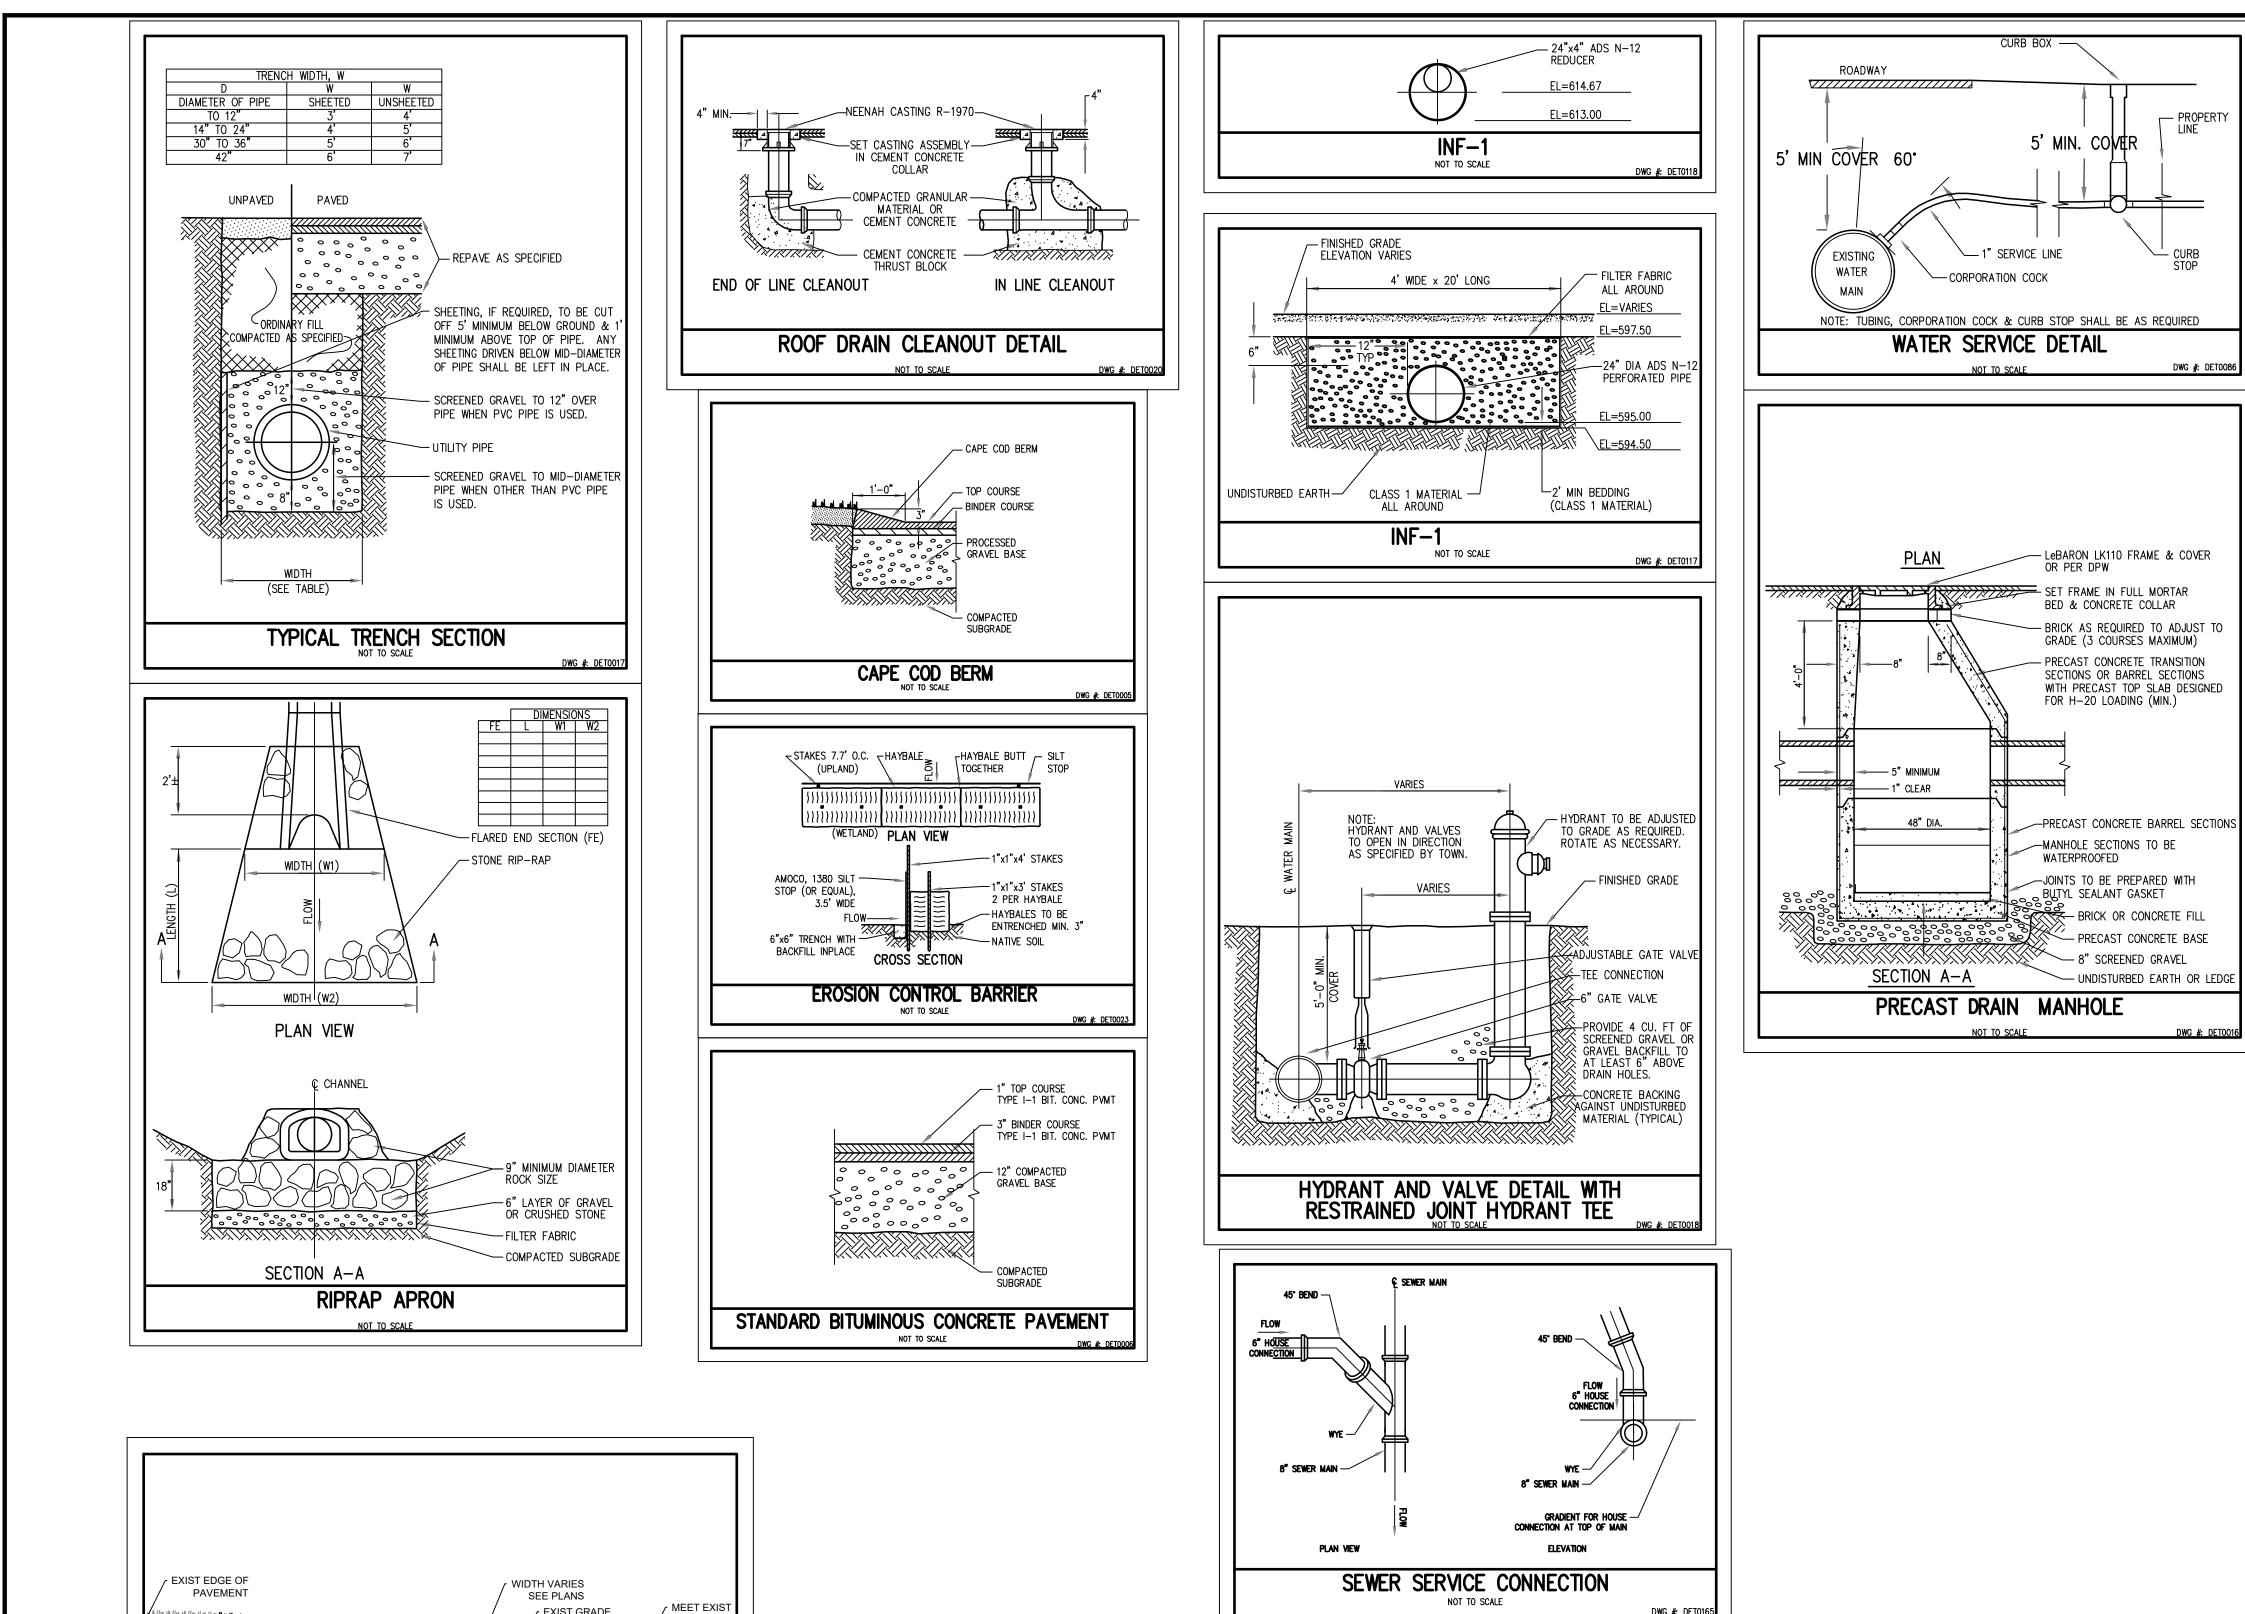


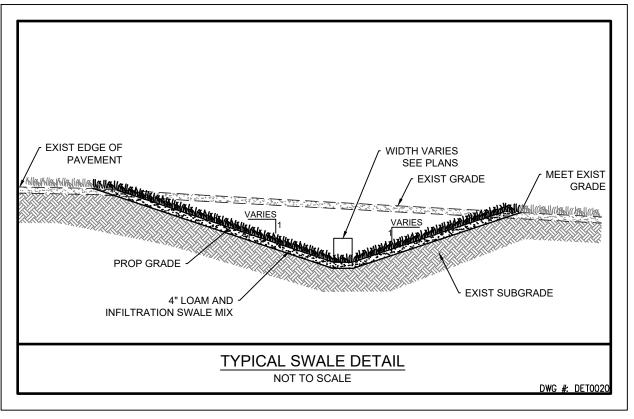


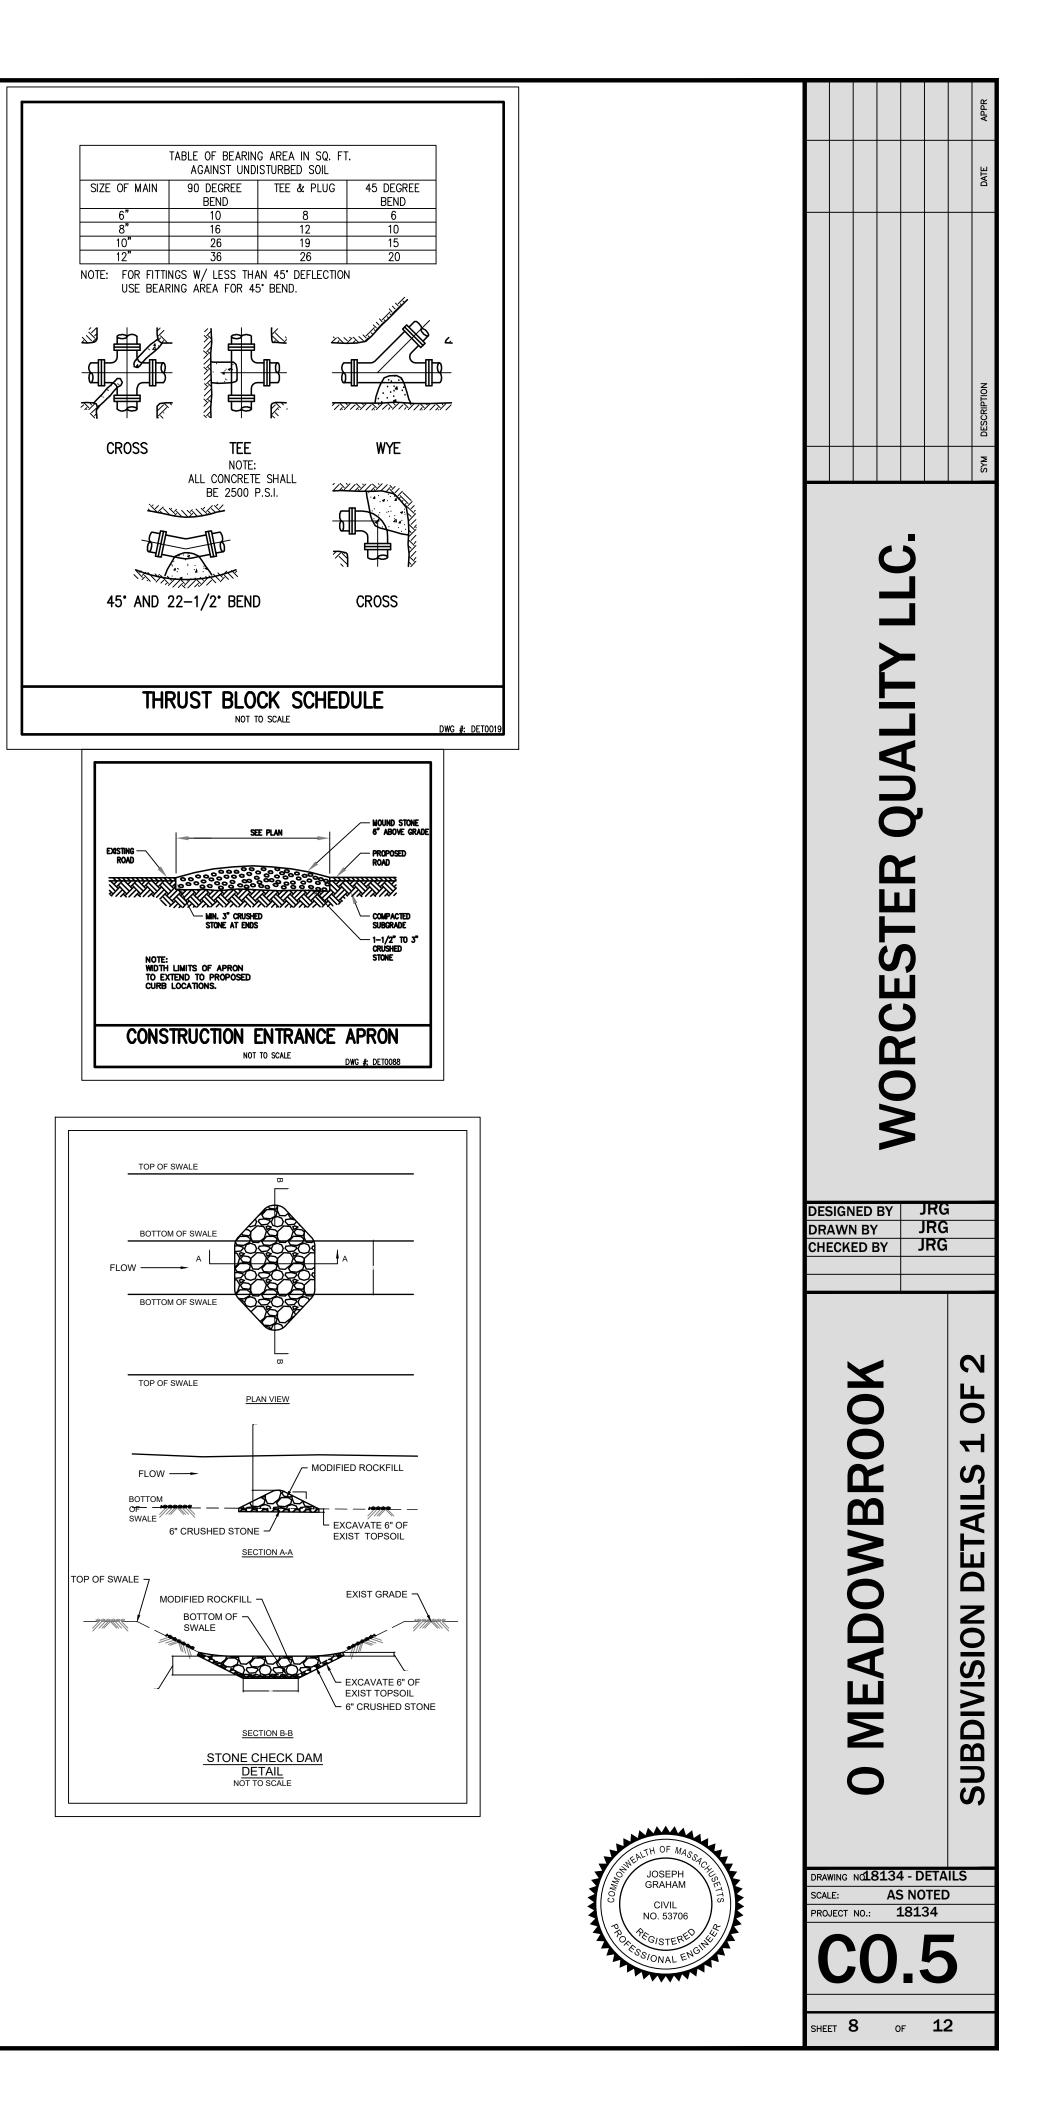

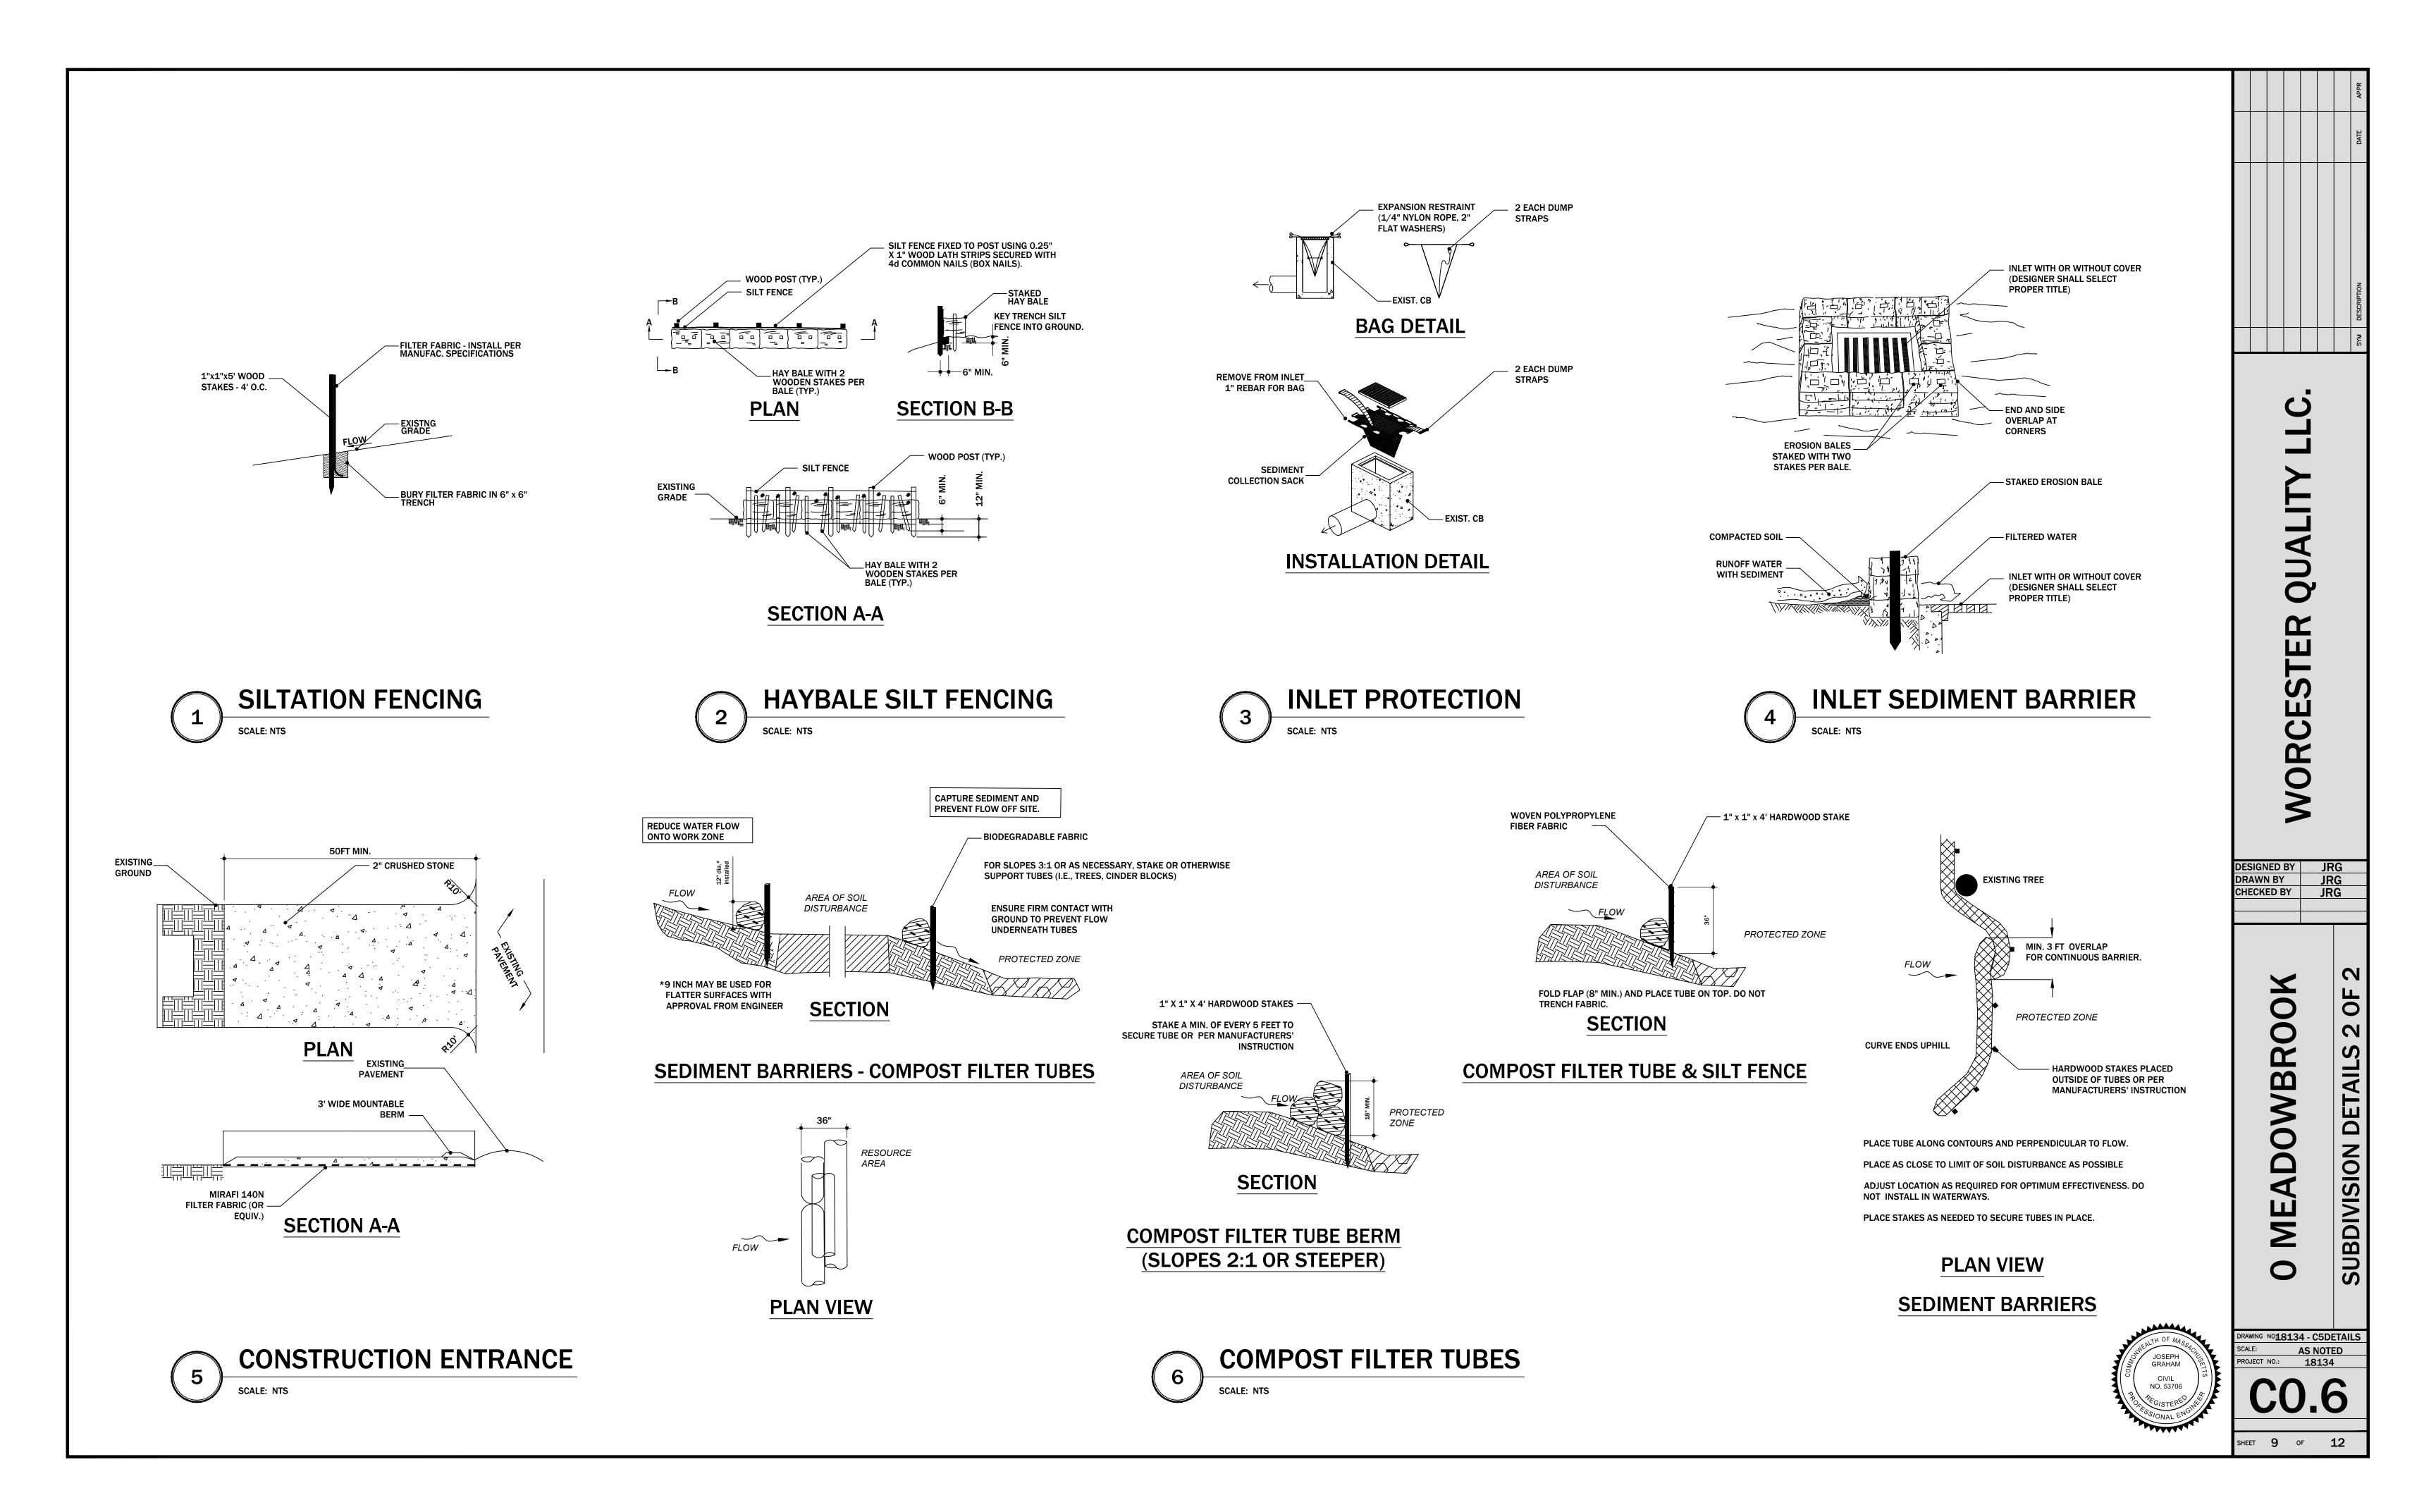

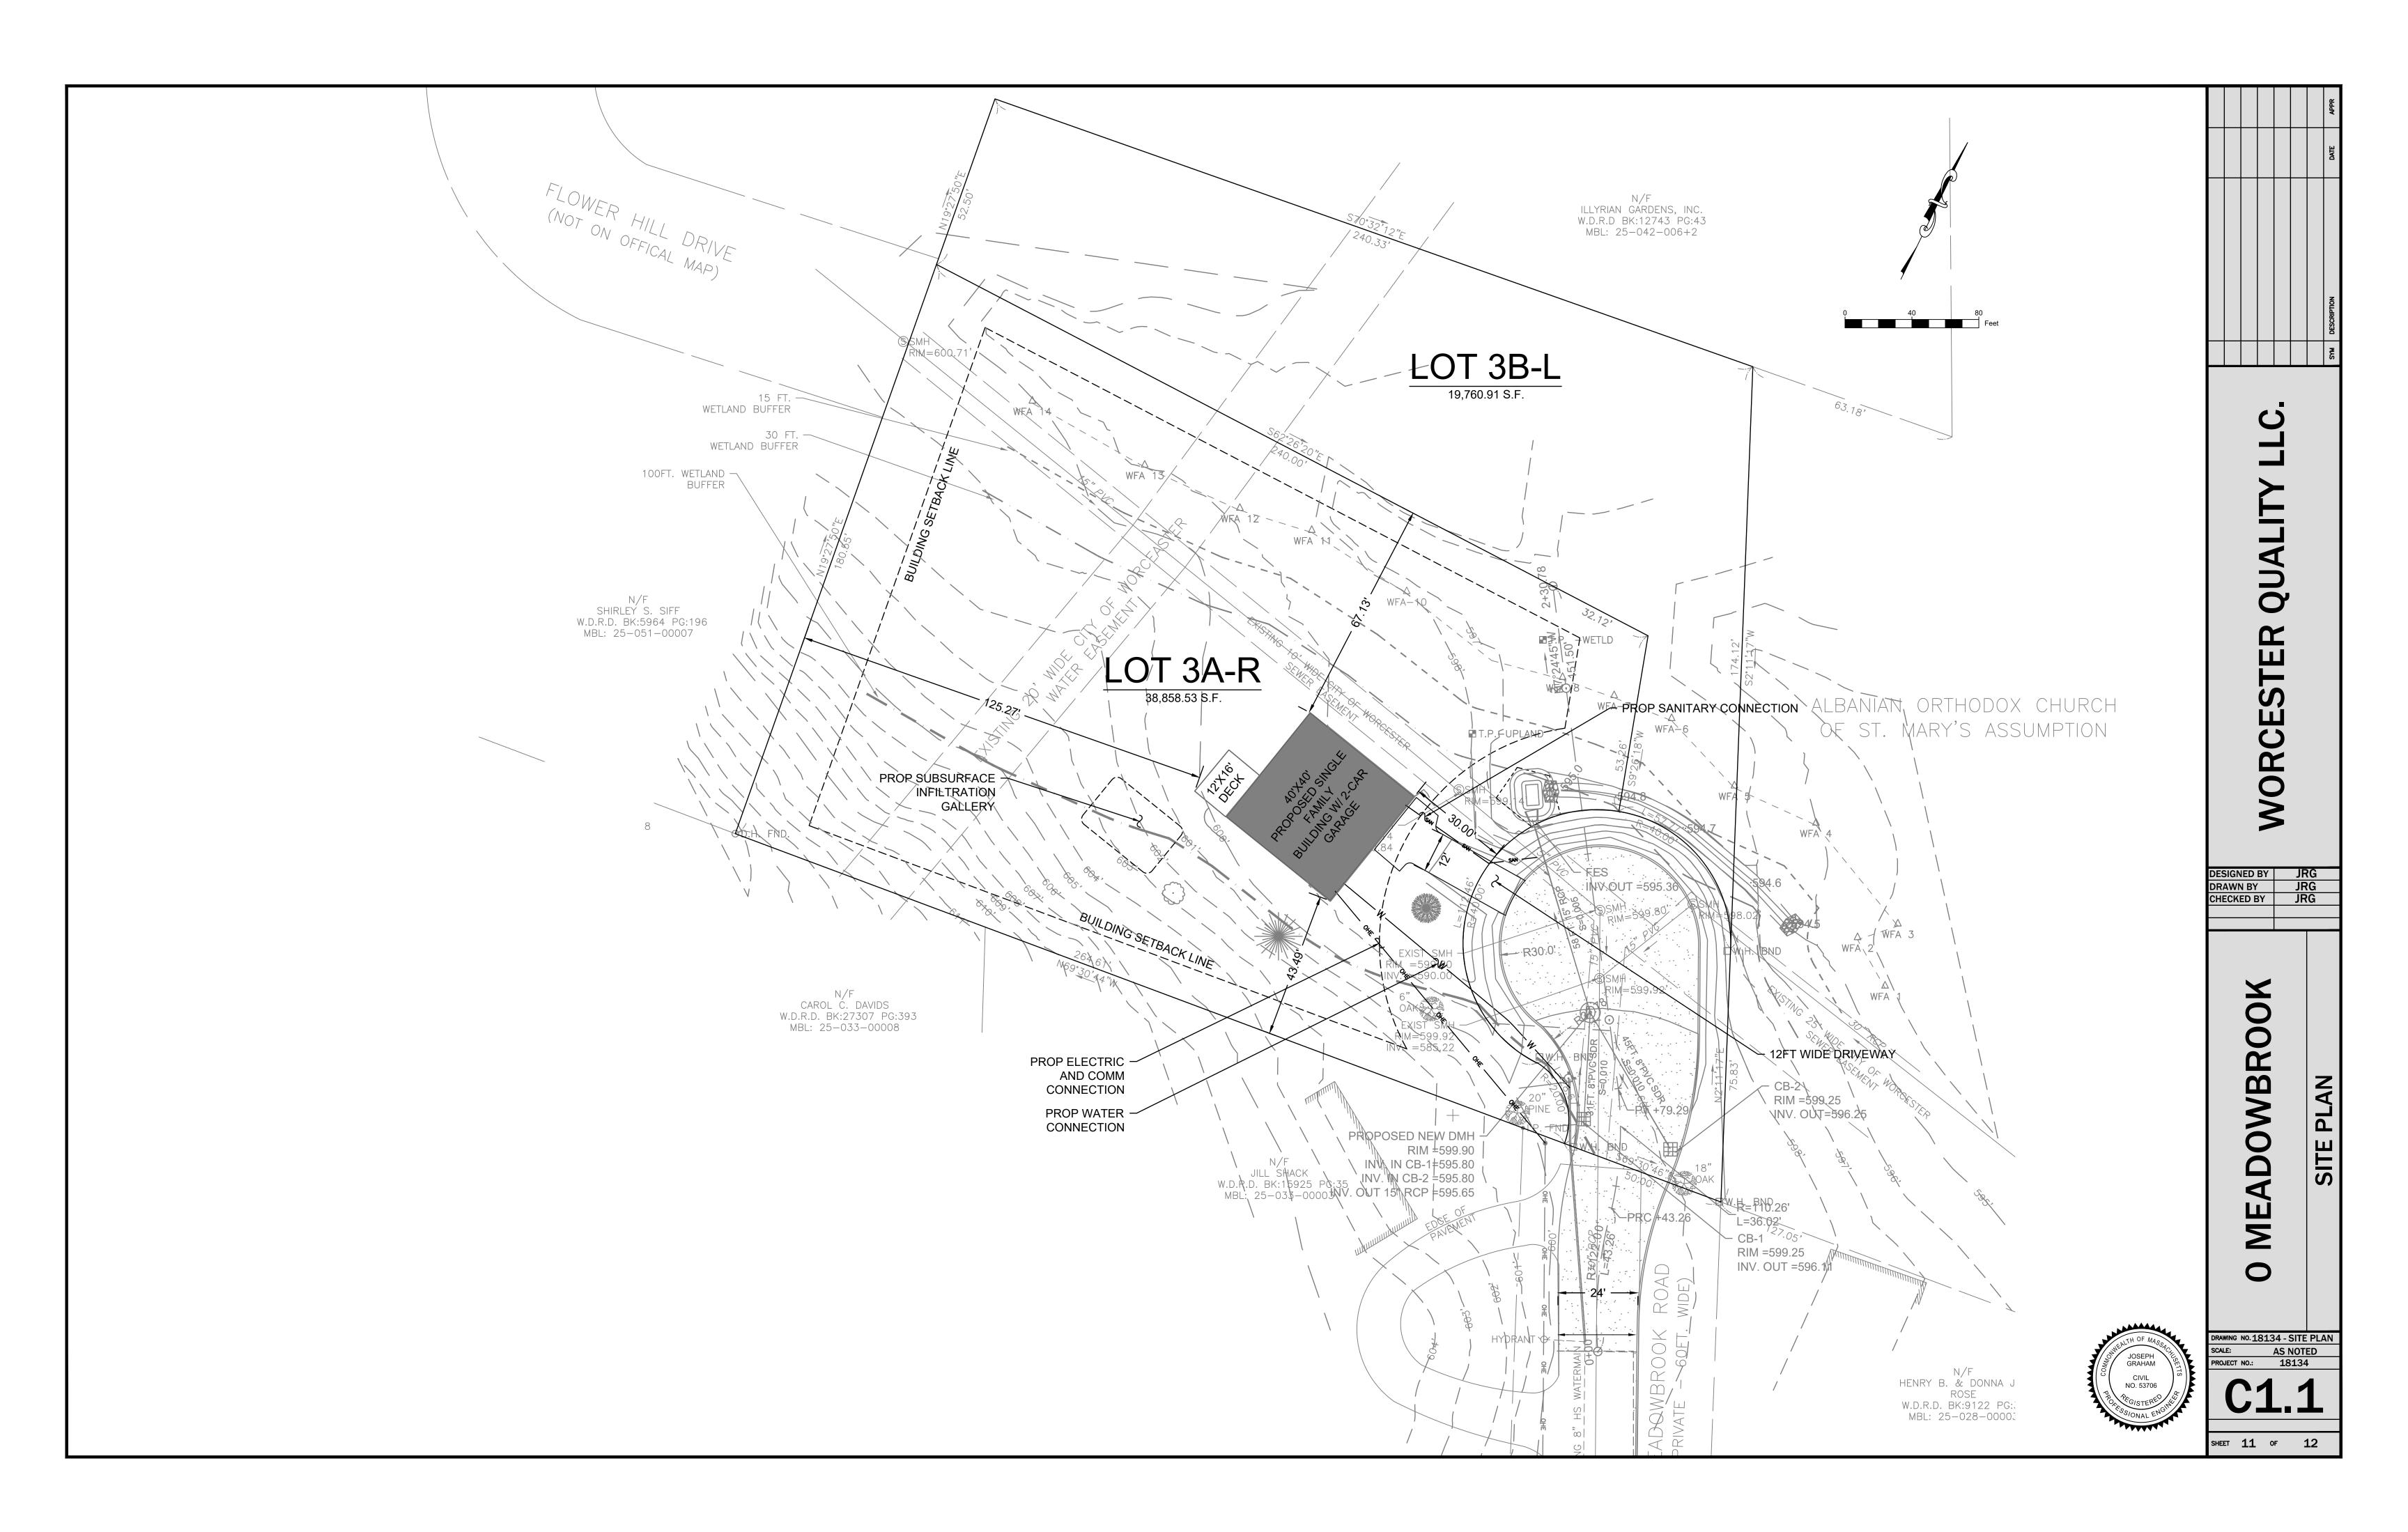

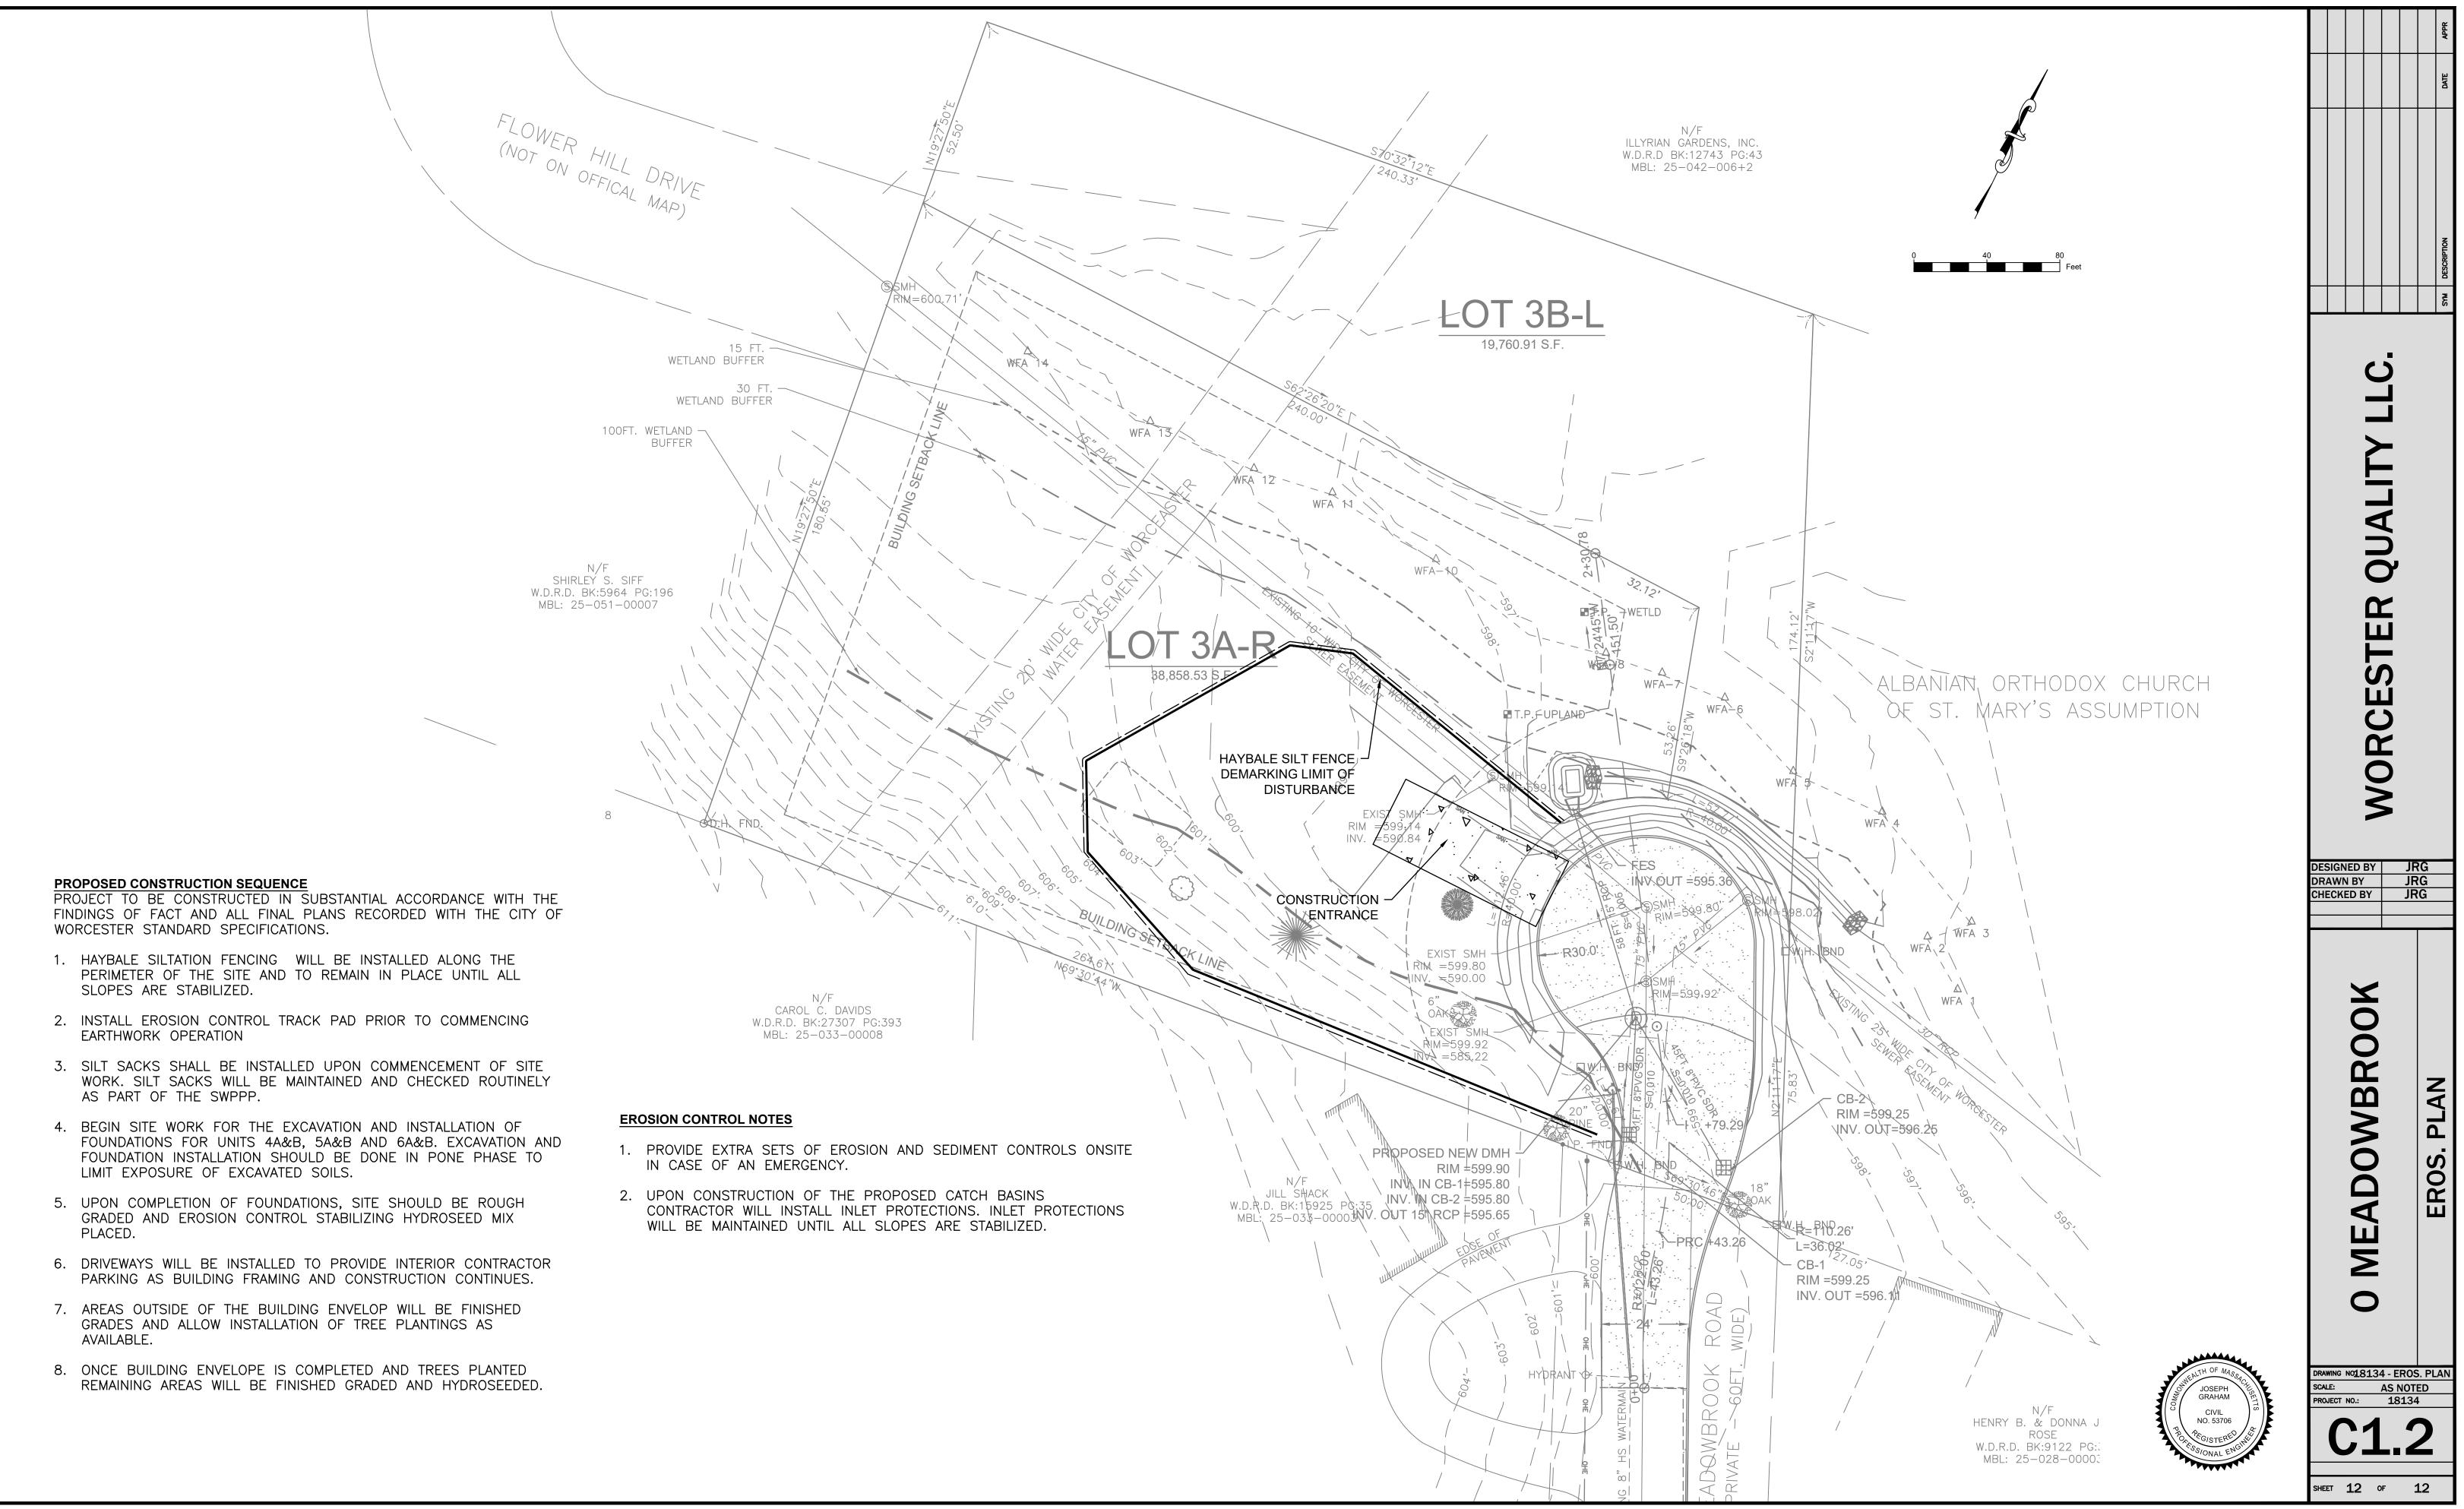

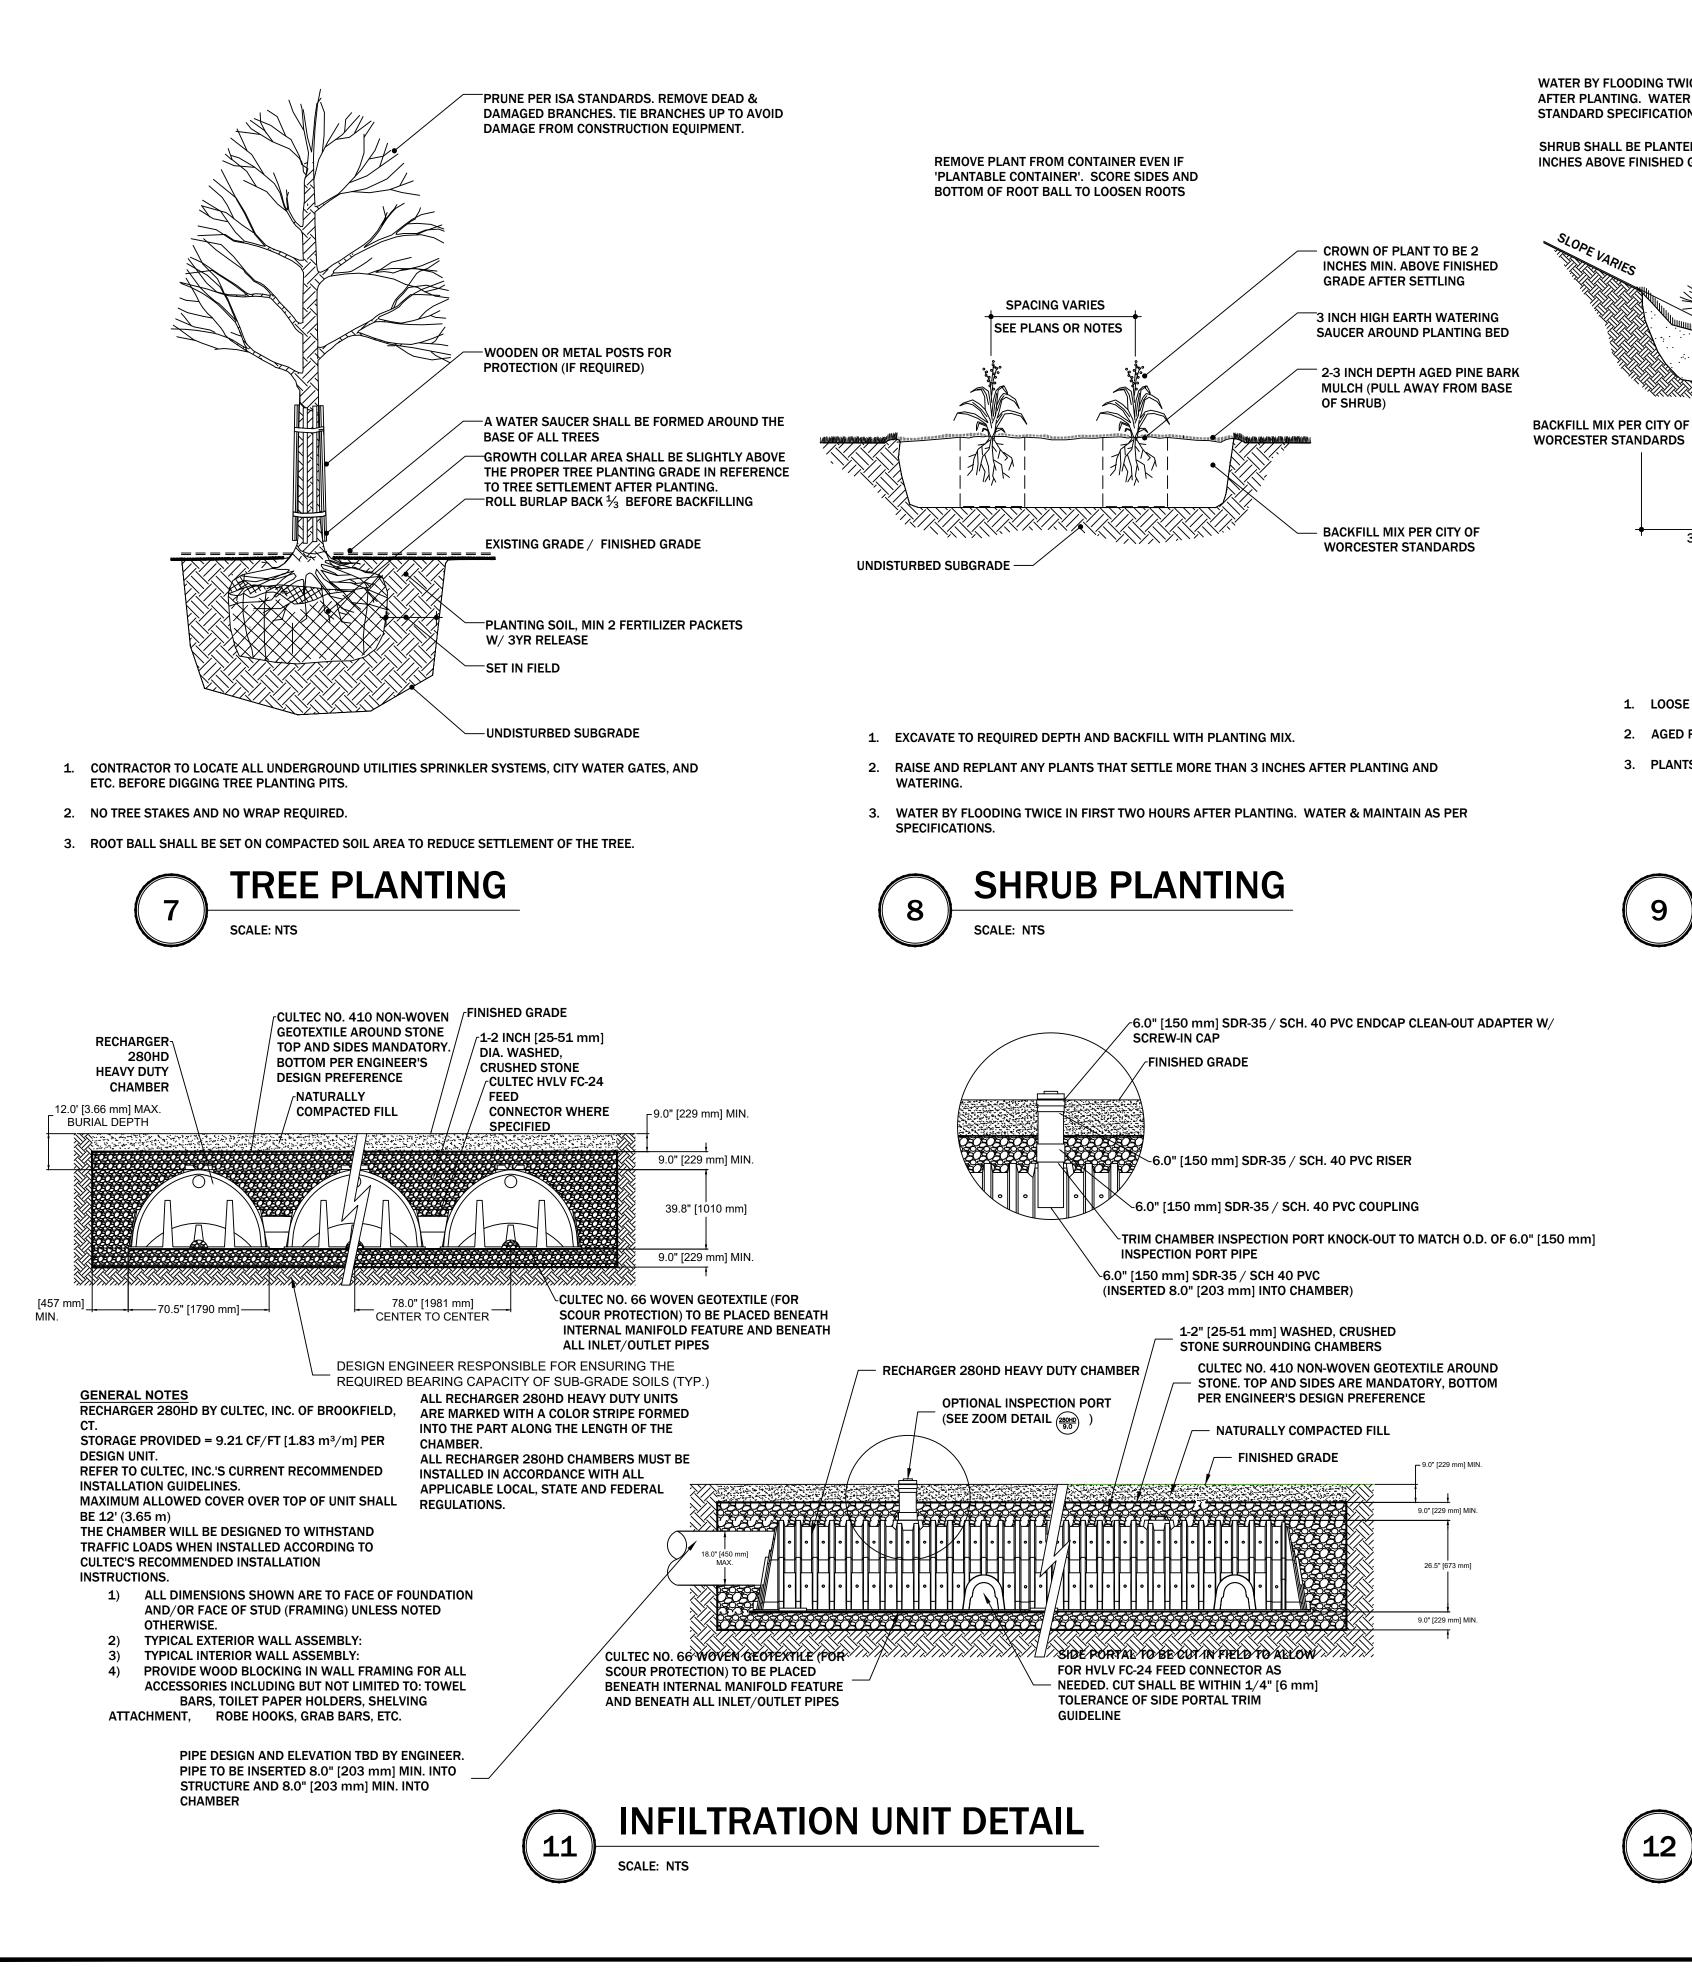



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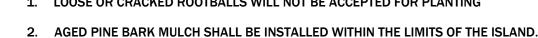
WXXXXXXXXXX

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 $_{
m \prime}$ 6.0" [150 mm] SDR-35 / SCH. 40 PVC ENDCAP CLEAN-OUT ADAPTER W/














SPACING VARIES



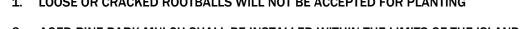





1V:1H SLOPE

MAX.



3. PLANTS SHALL BE LOCATED A MINIMUM OF 3 FEET FROM FACE OF PROPOSED CURB.

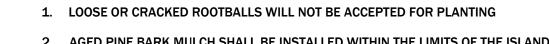

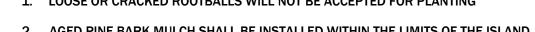







SHRUB SHALL BE PLANTED SO THAT CROWN IS 2 INCHES ABOVE FINISHED GRADE AFTER SETTLEMENT

WATER BY FLOODING TWICE IN FIRST TWO HOURS AFTER PLANTING. WATER & MAINTAIN AS PER STANDARD SPECIFICATIONS

3 X ROOTBALL

ADJUST SHRUBS SO THAT BOTTOM OF FOLIAGE IS EVENLY SPACED ABOVE THE GROUND

2-3 INCH DEPTH AGED PINE BARK MULCH (PULL AWAY

FROM BASE OF SHRUB)

AROUND SHRUB PIT

THE ROOT BALL

1" TOP COURSE

3" BINDER COURSE

12IN COMPACTED

- COMPACTED SUBGRADE

UNDISTURBED SUBGRADE

GRAVEL BASE

TYPE I-1 BIT. CONC. PVMT

TYPE I-1 BIT. CONC. PVMT

UNDISTURBED SUBGRADE

